


University of Louisville - Student Recreation Center (Phase #4 - Construction Set) Louisville, Ky

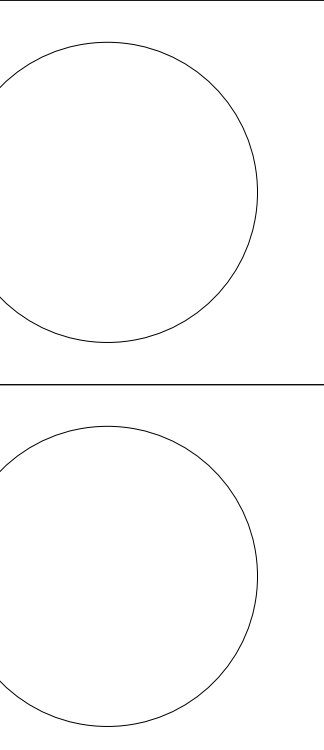

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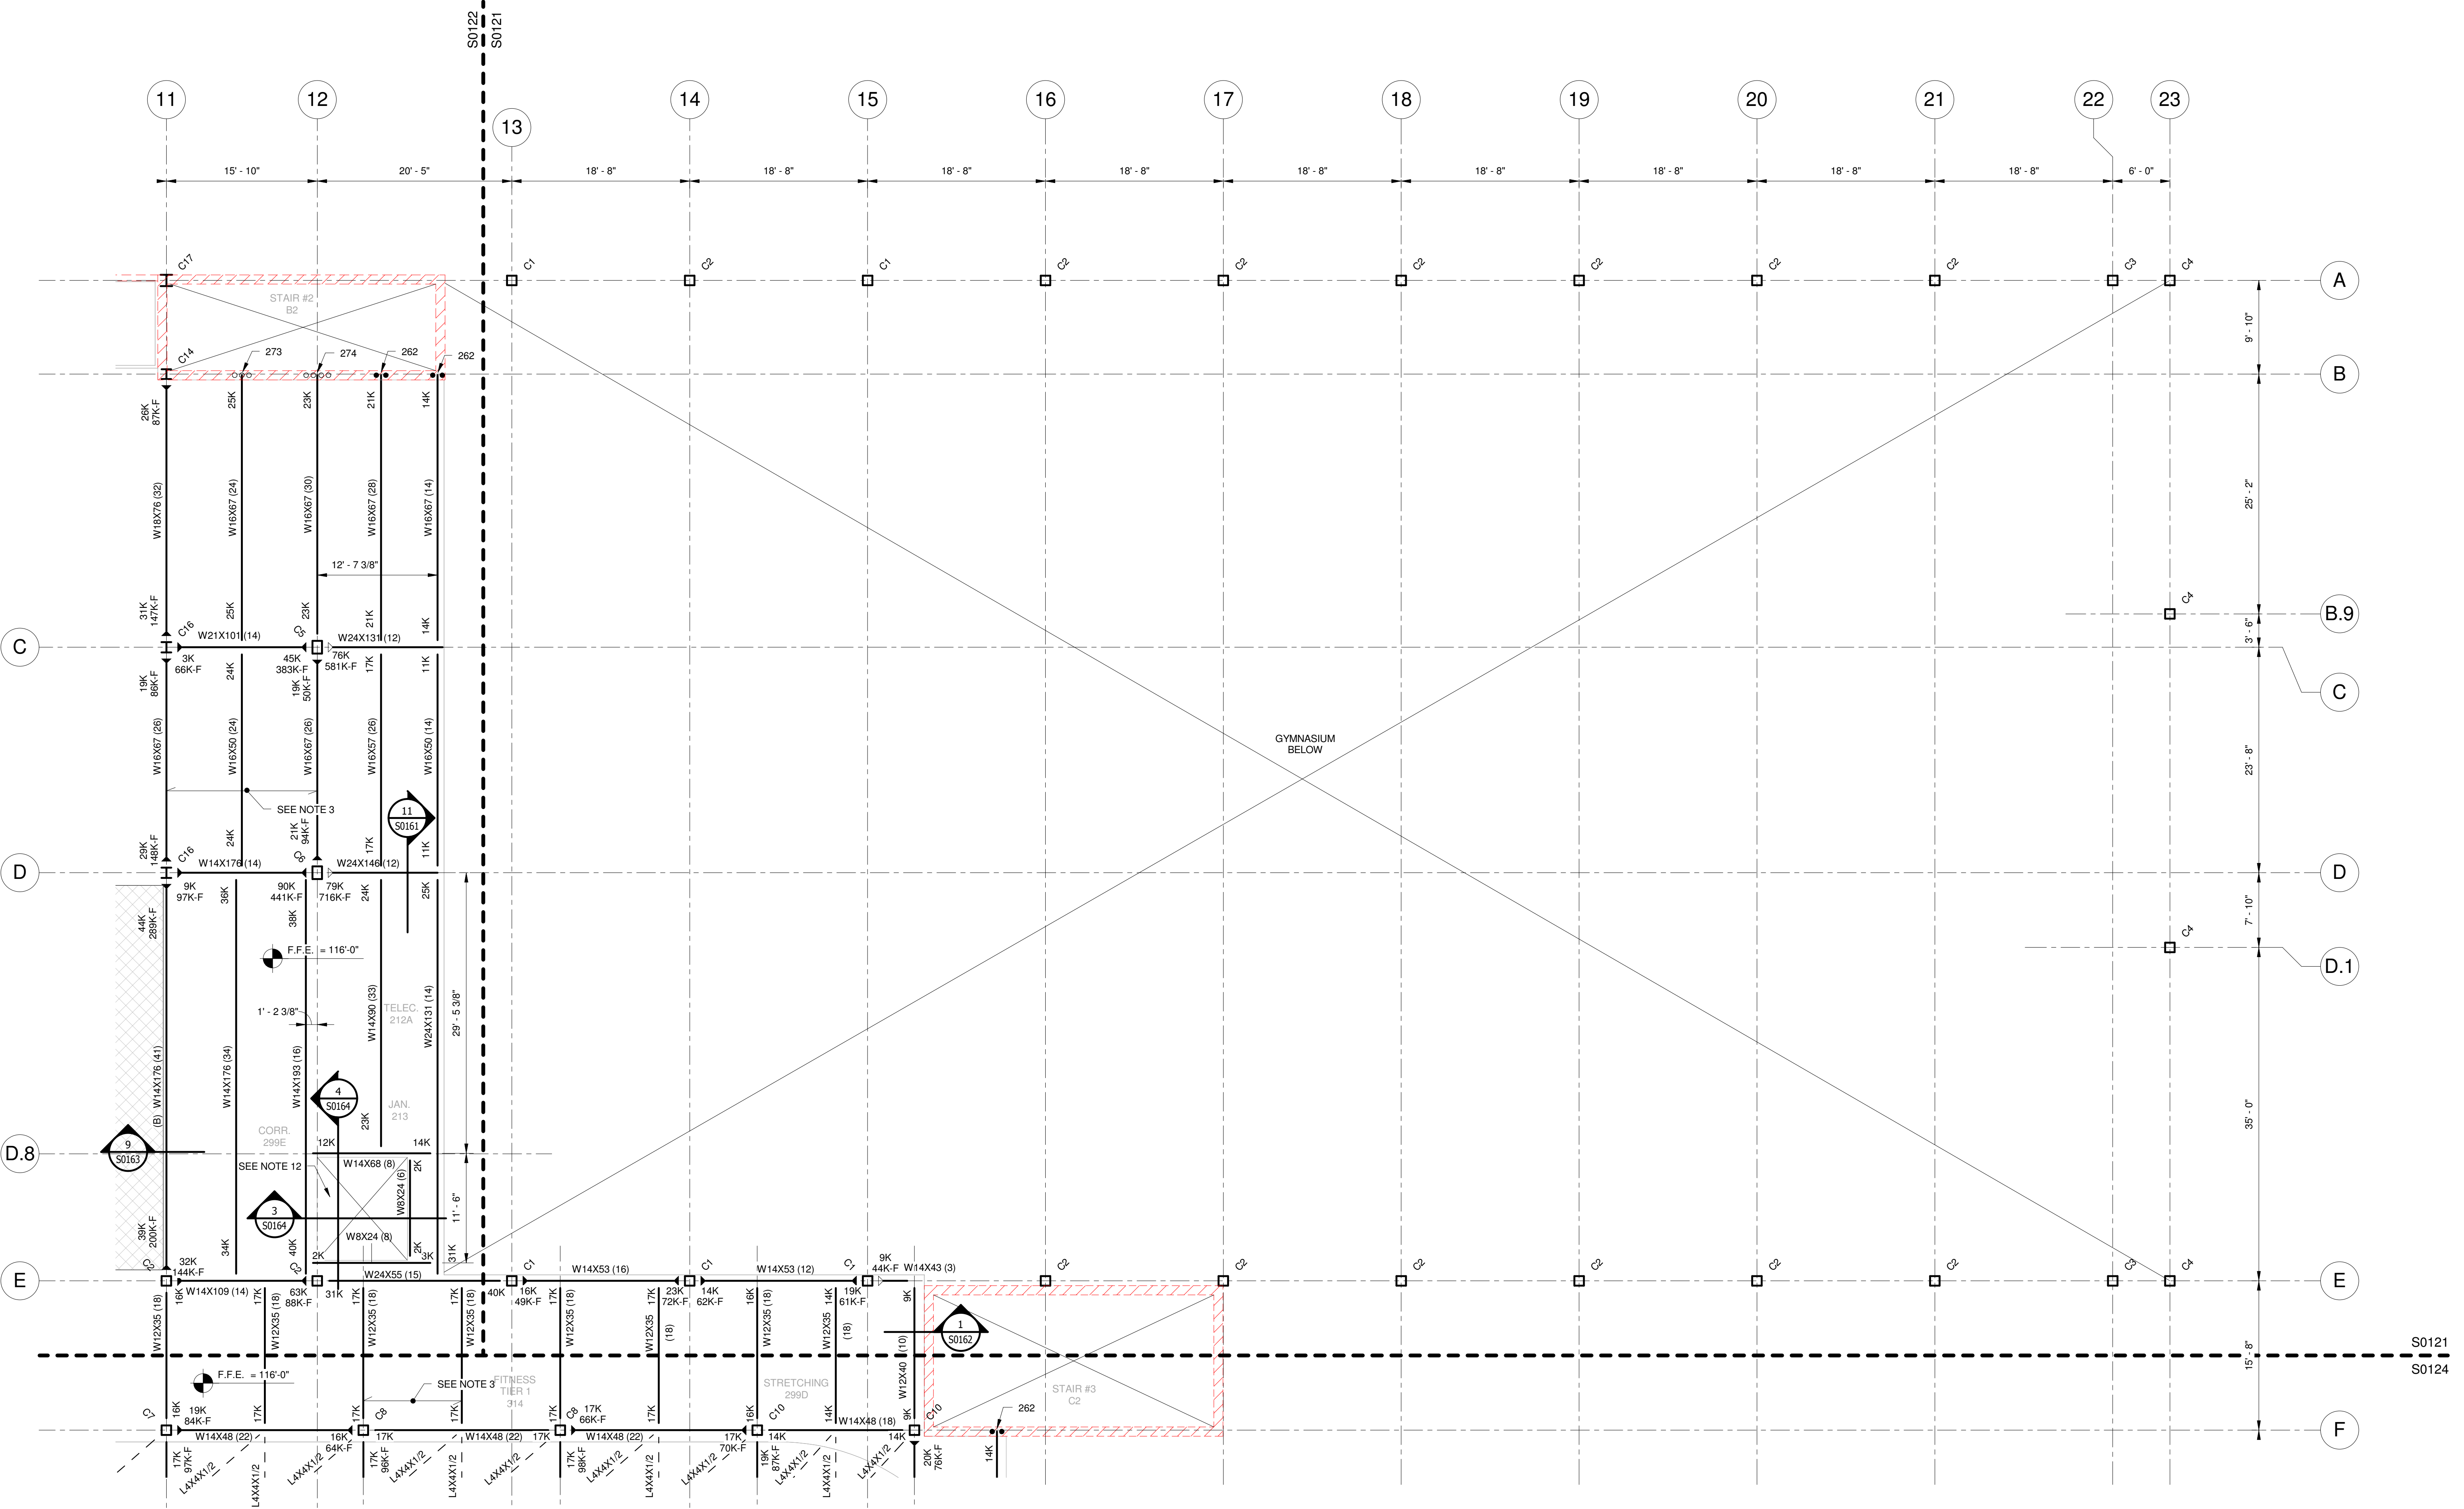
CANNONDESIGN

UNIVERSITY OF LOUISVILLE

#	Revision Date
4	Mar 12, 2012

Drawing Name: MEZZANINE FLOOR FRAMING PLAN- AREA-A
U of L Project Number: Omni - 1105.00
Project Number: Cannon - 08667.00
Date: April 16, 2012
Drawn By: VPP
Checked By: ANTHONY

S0121




MEZZANINE FLOOR FRAMING PLAN- AREA-A
SCALE: 1/8" = 1'-0"

MEZZANINE FLOOR FRAMING NOTES:

- ESTABLISHED ELEVATIONS:
F.F.E. 116'-0" UNO
TOP OF BEAM EL. 115'-5 3/4" UNO
ELEVATIONS ARE TO BE AS INDICATED ABOVE, UNLESS OTHERWISE NOTED +/- INCHES ABOVE/BELOW.
- MAXIMUM SPACING BETWEEN FLOOR BEAMS, AND BETWEEN ALL OTHER FLOOR BEARING MEMBERS, SHALL NOT EXCEED 11'-0" O.C.
- FLOOR SLAB [6 1/4" TOTAL DEPTH] 3 1/4" LIGHT WEIGHT CONCRETE w/W.F. 6#6 - W2XW2 ON 3 VLI, 18 GAGE GALVANIZED METAL DECK BY VULCRAFT OR APPROVED EQUIVALENT (TYP., U.N.O.)
- FLOOR SLAB [6 1/4" TOTAL DEPTH] 3 1/4" MIN. LIGHT WEIGHT CONCRETE w/W.F. 6#6 - W2XW2 ON 3 VLI, 18 GAGE GALVANIZED METAL DECK BY VULCRAFT OR APPROVED EQUIVALENT (TYP., U.N.O.) AND 4 3/4" TOPPING SLAB w/W.F. 4#4 - W3.5XW3.5 CONCRETE ABOVE INSULATION. SEE DETAIL (S0163).
- FLOOR SLAB [6 1/4" TOTAL DEPTH] 3 1/4" MIN. LIGHT WEIGHT CONCRETE w/W.F. 6#6 - W2XW2 ON 3 VLI, 18 GAGE GALVANIZED METAL DECK BY VULCRAFT OR APPROVED EQUIVALENT (TYP., U.N.O.) AND SLAB [6" TOTAL DEPTH] 2 1/2" MIN. LIGHT WEIGHT CONCRETE w/W.F. 6#6 - W1.4XW1.4 ON 1.5C, 20 GAGE GALVANIZED METAL DECK BY VULCRAFT OR APPROVED EQUIVALENT ABOVE ISO-LAT SYSTEM. SEE DETAIL (S0163).
- REFER TO ARCHITECTURAL, MECHANICAL, PLUMBING AND ELECTRICAL DRAWINGS FOR HOUSEKEEPING AND/OR EQUIPMENT PADS, CURB SIZES AND LOCATIONS. SIZES AND LOCATIONS OF PAD SHALL BE VERIFIED WITH APPROVED MANUFACTURER'S EQUIPMENT SHOP. DRAWING PRIOR TO CONSTRUCTION.
- ALL FLOOR DRAINS MAY NOT BE SHOWN. COORDINATE EXACT LOCATIONS AND QUANTITIES WITH THE PLUMBING DRAWING. PROVIDE POSITIVE SLOPES (WARPS) IN T.O. FLOOR SLAB IN ORDER TO PROVIDE REQUIRED DRAINAGE. COORDINATE FLOOR FINISHES WITH THE ARCHITECT.
- ALL BEAMS HAVE 1 ROW OF STUDS (UNO).
NUMBER OF STUDS PER BEAM DENOTED THUS ()
- COLUMN CALLOUT DENOTED THUS:
Cxx - COLUMN DESIGNATION
[SEE COLUMN SCHEDULE]
- PROVIDE #4@12" o.c. TOP TRANSVERSE, OVER ALL BEAMS W/#@12" o.c. LONGIT. (TYP.) SEE TYPICAL COMPOSITE SLAB REINF. DETAIL (10/S0208).
- REFER TO ARCHITECTURAL DRAWINGS AND MEP DRAWINGS FOR SLAB OPENINGS AND PENETRATIONS.
- REFER TO ARCHITECTURAL DRAWINGS FOR STAIR DIMENSION AND CONSTRUCTION, SLAB DEPRESSIONS AND ELEVATOR OPENINGS.
- SEE STRUCTURAL LINTEL ELEVATION SHEETS FOR LINTEL BEAMS AND METAL PANEL FRAMING DETAILS.
- PROVIDE 1/4" THICK BENT PLATE OR 1/4" THICK ANGLE FOR ALL DECK EDGE FRAMING. IF THE CANT. LENGTH IS LESS THAN OR EQUAL TO 1'-0", FOR COMPOSITE DECK EDGE DETAIL SEE S0202.
- PROVIDE ADDL. REINF. (2) #5 BENEATH NON-LOAD BEARING CMU WALLS FOUNDED ON FLOOR SLAB.
- PROVIDE SLIP CONNECTION PER DETAIL 2/S0200 FOR BEAMS BEARING ON MASONRY.
- COORDINATE WITH ARCH. FOR SLAB EDGE / BOUNDARY DETAILS.

- LEGENDS:**
- 12" REINFORCED CMU w/2) #6 IN EACH CORE
 - 12" REINFORCED CMU w/2) #7 IN EACH CORE
 - LOAD BEARING CMU WALL AND/OR EXTERIOR CMU WALL ABOVE
 - 252 - ADDITIONAL VERTICAL CMU REINF. REQUIRED (SEE TYPICAL DETAIL)
 - LOAD BEARING CMU WALL AND/OR EXTERIOR CMU WALL BELOW
 - STANDARD S.J.I. BRIDGING
 - INDICATES MOMENT CONNECTION BY OTHERS.
 - INDICATES CANTILEVER MOMENT CONNECTION BY OTHERS.
 - REFER TYPICAL DETAIL 14/S0200 FOR BEAM AND COLUMN CONNECTION. (U.N.O.)
 - (A) - INDICATES TOP OF STEEL ELEVATION 114'-10"
 - (B) - INDICATES TOP OF STEEL ELEVATION 115'-3 7/8"
 - (C) - INDICATES TOP OF STEEL ELEVATION 137'-1 1/2"
 - (D) - INDICATES TOP OF STEEL ELEVATION 115'-1 3/4"
 - (E) - INDICATES TOP OF STEEL ELEVATION 113'-4 3/8"
 - (F) - INDICATES W17X96.5 ABOVE BEAM, T.O.S. EL. 115'-5 3/4"
 - (H1) - INDICATES HSS3X3X1/4 ABOVE ROOF BEAM, T.O.S. EL. VARIES, SEE PLAN
 - (H2) - INDICATES HSS3X2 1/2X3/16 ABOVE FLOOR BEAM, T.O.S. EL. 137'-1 1/2"
 - (H3) - INDICATES HSS8X8X1/2 ABOVE ROOF BEAM, T.O.S. EL. VARIES, SEE PLAN
 - (H4) - INDICATES HSS10X10X1/2 ABOVE ROOF BEAM, T.O.S. EL. VARIES, SEE PLAN
 - AEROBICS STORAGE FLOOR SLAB - 7 3/4" DEPRESSION
 - AEROBICS FLOOR SLAB - 7 3/4" DEPRESSION
 - RACQUET BALL FLOOR SLAB - 1 7/8" DEPRESSION
 - GYM FLOOR SLAB - 2 1/2" DEPRESSION

DISCLAIMER NOTE:
THIS SET OF CONSTRUCTION DRAWINGS HAS BEEN UPDATED TO INCLUDE ANY CHANGES ISSUED THROUGH ADDENDUM OR OTHER MEANS. EVERY EFFORT HAS BEEN TAKEN TO INCLUDE ALL CHANGES TO DATE. THE CONTRACTOR IS STILL RESPONSIBLE FOR PROVIDING ANY ITEMS THAT WERE SHOWN AS PART OF THE ORIGINAL BID SET THAT MAY HAVE BEEN OVERLOOKED AND NOT INCLUDED IN THIS SET.

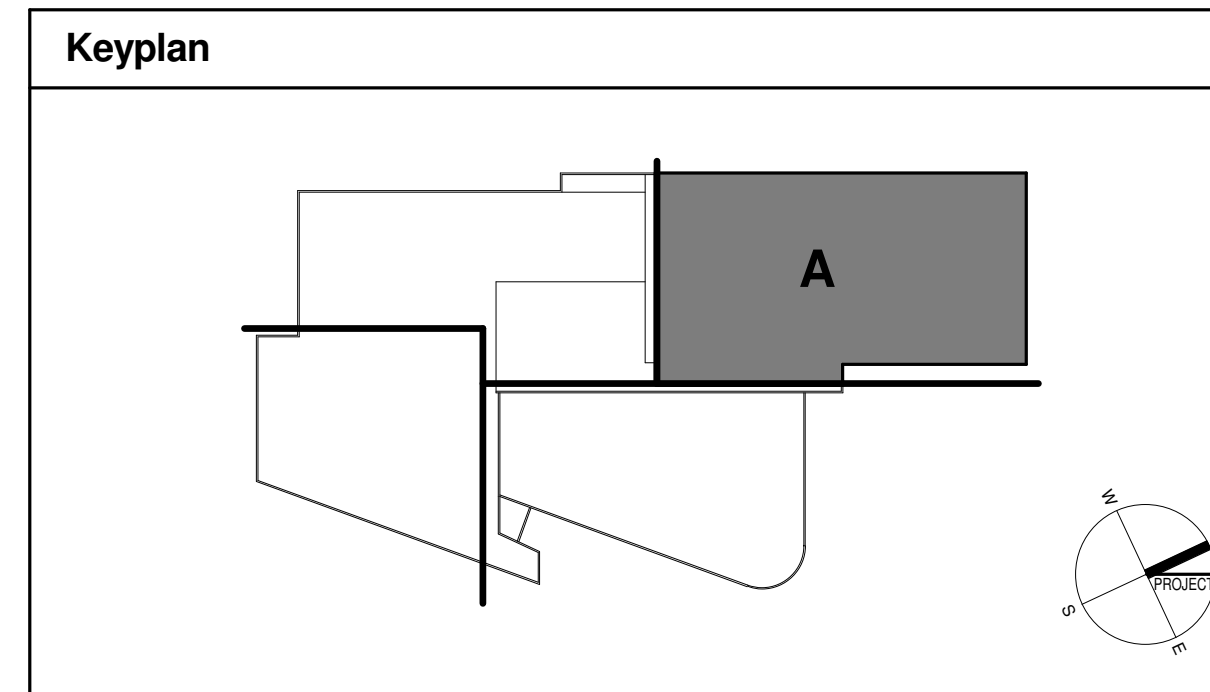

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