

### GENERAL NOTES


- COORDINATE THE LOCATION OF DRAINS, GAS OUTLETS, ETC., WITH ALL CASEWORK EQUIPMENT, MECHANICAL ROOM EQUIPMENT, ETC., PRIOR TO COMMENCING INSTALLATION. WORK NOT SO COORDINATED SHALL BE REMOVED AND PROPERLY INSTALLED AT THE EXPENSE OF THE CONTRACTOR.
- THE CONTRACTOR SHALL EXERCISE EXTREME CARE IN THE COURSE OF THEIR WORK SO AS TO INSURE THAT THEY DO NOT INTERRUPT ANY EXISTING SERVICE. FOR SAFETY PURPOSES, PAY PARTICULAR ATTENTION TO THIS PRECAUTION RELATIVE TO NATURAL GAS AND ELECTRICAL LINES. VERIFY THE LOCATION, SIZE, TYPE, ETC., OF EACH UNDERGROUND OR OVERHEAD UTILITY. ALL WORK SHALL BE PERFORMED IN ACCORD WITH ALL FEDERAL, STATE AND/OR LOCAL RULES, REGULATIONS, STANDARD AND SAFETY REQUIREMENTS. UTILITIES SHALL BE INSTALLED IN ACCORD WITH THE APPLICABLE MUNICIPALITY OR UTILITY COMPANY STANDARDS. IN ALL CASES, THE MOST STRINGENT REQUIREMENT SHALL APPLY.
- WHERE WORK IS REQUIRED ABOVE EXISTING LAY-IN, PLASTER OR GYPSUM BOARD CEILINGS, THE CONTRACTOR SHALL BE RESPONSIBLE FOR REMOVAL AND REINSTALLATION (OR REPLACEMENT, IF DAMAGED) OF ALL CEILING OR TILE AND GRID MEMBERS NECESSARY TO PERFORM HIS WORK. NEW TILE AND GRID SHALL MATCH THE SURROUNDING AREAS. ALL PATCHING WORK SHALL MATCH ADJACENT SURFACES.
- ALL NEW WORK SHALL BE HUNG FROM STRUCTURE, NOT FROM THE WORK OF OTHER TRADES, WHETHER EXISTING OR NEW.
- COORDINATE ALL WORK WITH PROJECT PHASING REQUIREMENTS.
- PATCH, REPAIR AND PAINT OR PROVIDE WALL COVERING FOR (TO OWNER'S STANDARDS) EXISTING WALLS, CEILINGS, ETC., THAT ARE TO REMAIN IF DAMAGED DURING CONSTRUCTION. REPAIRS SHALL MATCH ADJACENT SURFACES TO THE SATISFACTION OF THE ARCHITECT AND
- IN ACCORDANCE WITH K.R.S. ALL PLUMBING WORK SHALL BE CONSTRUCTED IN COMPLIANCE WITH PLANS APPROVED BY AND BEARING THE APPROVAL STAMP OF THE KENTUCKY DIVISION OF PLUMBING AND, OR THE DIVISION OF WATER. THE CONTRACTOR SHALL NOT BEGIN WORK UNTIL HE HAS RECEIVED SUCH APPROVED PLANS.
- OBSERVE ALL APPLICABLE CODES, RULES AND REGULATIONS THAT MAY APPLY TO THE WORK UNDER THIS CONTRACT. (CITY, COUNTY, LOCAL, FEDERAL, MUNICIPALITY, UTILITY COMPANY, COMMONWEALTH OF KENTUCKY,
- THE CONTRACTOR IS RESPONSIBLE FOR ALL UTILITY COMPANY FEES OR OTHER COSTS THAT ANY UTILITY COMPANY MAY REQUIRE TO COMPLETE THEIR WORK. (GAS, SEWER, WATER, ETC.).
- CONTRACTOR SHALL BE AWARE OF UNSEEN PLUMBING WORK DURING DEMOLITION. IF ITEMS ARE UNCOVERED DURING DEMOLITION THEN FIELD VERIFY THE USE OF THE ITEMS AND PLAN AN ALTERNATE ROUTE TO RUN THESE ITEMS. THEN CONTACT THE ENGINEERS TO REVIEW THE
- IF AREA OF CONSTRUCTION HAS A POST TENSION FLOOR SLAB. CONTRACTOR SHALL USE ULTRA SOUND OR OTHER APPROVED METHODS TO SURVEY THE EXISTING FLOOR STRUCTURE BEFORE MAKING ANY AND ALL FLOOR PENETRATIONS.
- WHERE FIRE PROOFING IS SPRAYED ON EXISTING STRUCTURE ALL EXISTING CONDUITS, WATER, HYDRONIC, STEAM, CHILLED WATER, FIRE PROTECTION LINES, MED GAS, ETC. SHALL BE LOWERED TO BE BELOW FULL THICKNESS OF FIRE PROOFING WITH NO INTERFERENCE.
- ALL PENETRATIONS OF FIRE AND SMOKE RATED ASSEMBLIES SHALL BE APPROPRIATELY FIRE STOPPED PER AN APPROVED U.L. LISTED STANDARD. CONTRACTOR SHALL PAY PARTICULAR ATTENTION TO INSULATED PIPING PENETRATIONS.
- ALL WORK REQUIRING DOWNTIME OF ANY AREA OUTSIDE OF THE COUNCIL BUILDING SHALL BE SCHEDULED 2 WEEKS IN ADVANCE, AND SHALL COMPLY WITH INTERIM LIFE SAFETY MEASURES.
- ALL PIPING IN ROOMS WITH CEILINGS SHALL BE ABOVE CEILING EXCEPT
- LOCATIONS OF PIPING AND EQUIPMENT ARE APPROXIMATE AND SUBJECT TO MINOR ADJUSTMENTS IN THE FIELD. DO NOT SCALE THE DRAWINGS.
- ALL OFFSETS IN PIPING ARE NOT NECESSARILY SHOWN. PROVIDE ADDITIONAL OFFSETS WHERE NECESSARY.
- INSTALL ALL PIPING AND EQUIPMENT IN STRICT ACCORDANCE WITH MANUFACTURER'S INSTALLATION INSTRUCTION. IF IN CONFLICT WITH THE DESIGN INDICATED IN CONTRACT DOCUMENTS, ADVISE THE ENGINEERS PRIOR TO INSTALLATION FOR CLARIFICATION. PROVIDE RECOMMENDED ACCESS AND SERVICE CLEARANCES FOR ALL EQUIPMENT.
- SEAL AIRTIGHT AROUND ALL DUCTS AND PIPING PENETRATIONS THROUGH WALLS, FLOORS AND ROOF. PROVIDE FIRE STOPPING IN FIRE PARTITION.
- THE CONTRACTOR SHALL RELOCATE OR AVOID ANY EXISTING EQUIPMENT APPURTENANCES, ETC., THAT CONFLICT WITH NEW WORK.
- WHERE MOUNTING HEIGHTS ARE NOT INDICATED OR ARE IN CONFLICT WITH ANY OTHER BUILDING SYSTEM, CONTACT THE ENGINEERS BEFORE INSTALLATION. REFER ALSO TO ARCHITECTURAL WALL INTERIOR AND EXTERIOR WALL ELEVATIONS, CEILING HEIGHTS AND OTHER DETAIL OF THESE DOCUMENTS.
- DEVIATIONS IN SIZE, CAPACITIES, FIT, FINISH, ETC. FOR EQUIPMENT FROM THAT USED AS BASIS OF DESIGN SHALL BE THE RESPONSIBILITY OF THE PURCHASER OF THAT EQUIPMENT. ANY PROVISIONS REQUIRED TO ACCOMMODATE A DEVIATION, WHETHER APPROVED BY THE ENGINEERS OR NOT, SHALL BE THE RESPONSIBILITY OF THE PURCHASER.
- VALVES OR ANY PLUMBING ITEM REQUIRING ACCESS SHALL NOT BE LOCATED ABOVE A HARD CEILING. IF THIS IS NOT POSSIBLE, THEN AN APPROPRIATELY SIZED ACCESS DOOR SHALL BE PLACED UNDER THE ITEM TO ALLOW EASY MAINTENANCE AND ADJUSTMENT. ADDITIONALLY ALL SUCH ITEMS SHALL NOT BE LOCATED AN UNREASONABLE DISTANCE ABOVE THE CEILINGS. IN GENERAL ALL SUCH ITEMS UNLESS INDICATED OTHERWISE SHALL BE MOUNTED SIX TO TWELVE INCHES ABOVE THE CEILING. IF IN DOUBT, CONTACT ENGINEER PRIOR TO INSTALLING.
- ALL MANHOLES, VAULTS AND SIMILAR UNDERGROUND STRUCTURES SHALL HAVE THE TOP ELEVATION SET FLUSH WITH FINISHED GRADE UNLESS SPECIFICALLY NOTED OTHERWISE.
- WHEN RUNNING ANY TYPE OF PIPING BELOW A FOOTER, OR IN THE ZONE OF INFLUENCE THE PIPING SHALL BE BACKFILLED WITH CEMENTITIOUS FLOWABLE FILL PER SPECIFICATIONS. WHENEVER POSSIBLE, LOCATE PIPING OUTSIDE OF THE ZONE OF INFLUENCE. THE ZONE OF INFLUENCE IS THE AREA UNDER THE FOOTER WITHIN A 45 DEGREE ANGLE PROJECTING DOWN FROM THE BOTTOM EDGE OF THE FOOTER OF ALL SIDES OF THE FOOTER. ADDITIONALLY, GREASE TRAPS, MANHOLES, VAULTS AND OTHER UNDERGROUND STRUCTURES SHALL BE HELD AWAY FROM BUILDING WALLS FAR ENOUGH TO BE OUTSIDE OF THE ZONE OF

INFLUENCE.

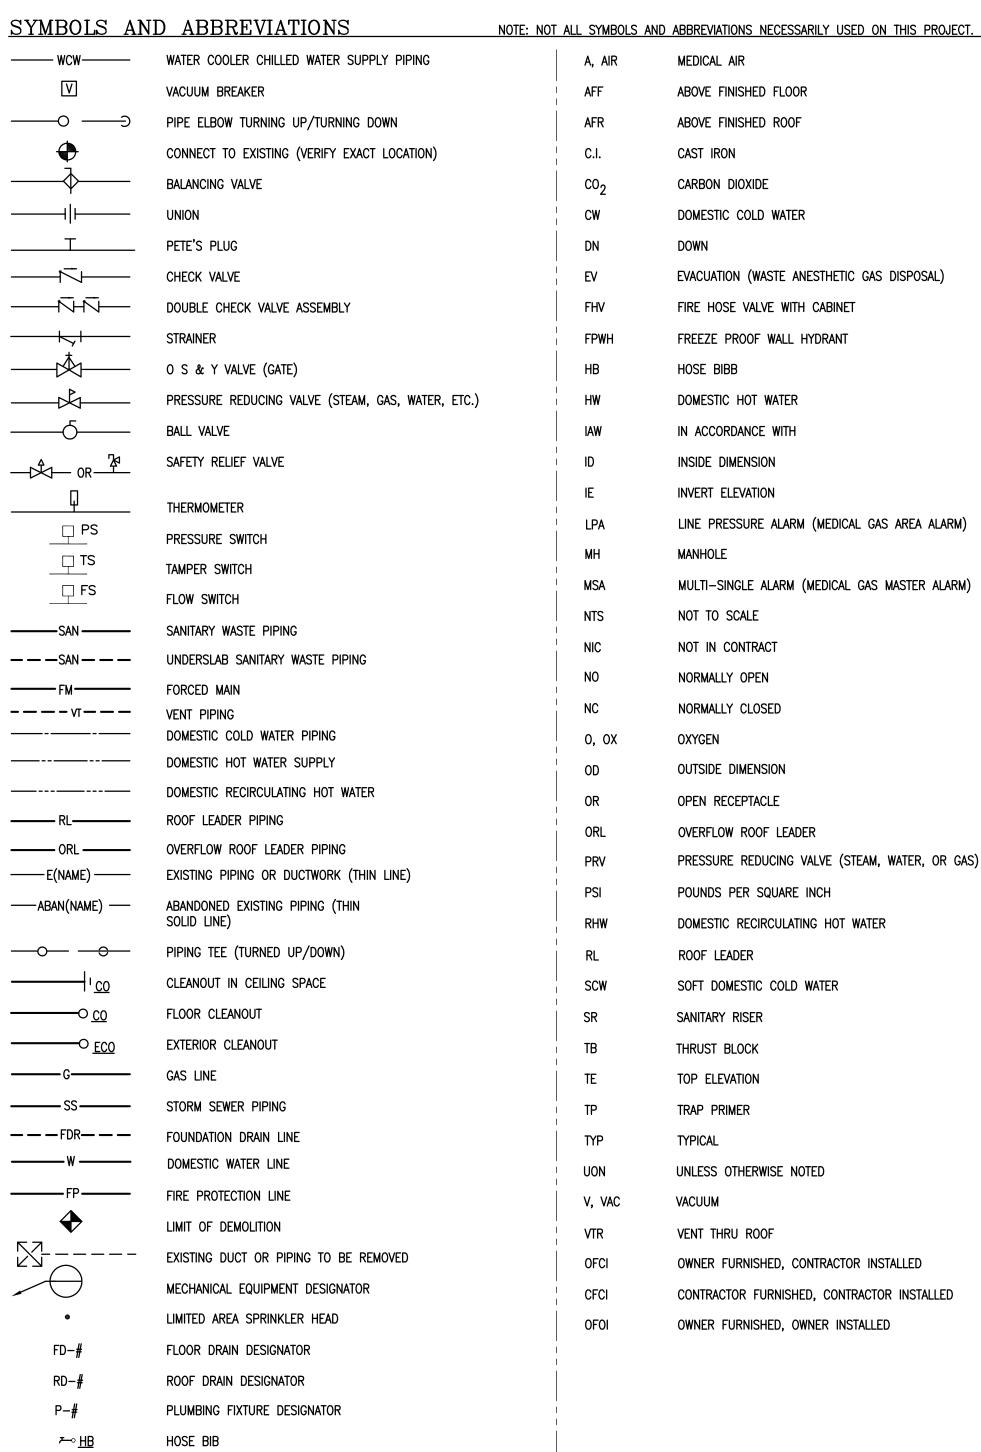

# EVACUATION (WASTE ANESTHETIC GAS DISPOSAL) FIRE HOSE VALVE WITH CABINET FREEZE PROOF WALL HYDRANT LINE PRESSURE ALARM (MEDICAL GAS AREA ALARM) MULTI-SINGLE ALARM (MEDICAL GAS MASTER ALARM) PRESSURE REDUCING VALVE (STEAM, WATER, OR GAS) POUNDS PER SQUARE INCH DOMESTIC RECIRCULATING HOT WATER SOFT DOMESTIC COLD WATER UNLESS OTHERWISE NOTED OWNER FURNISHED, CONTRACTOR INSTALLED CONTRACTOR FURNISHED, CONTRACTOR INSTALLED OWNER FURNISHED, OWNER INSTALLED

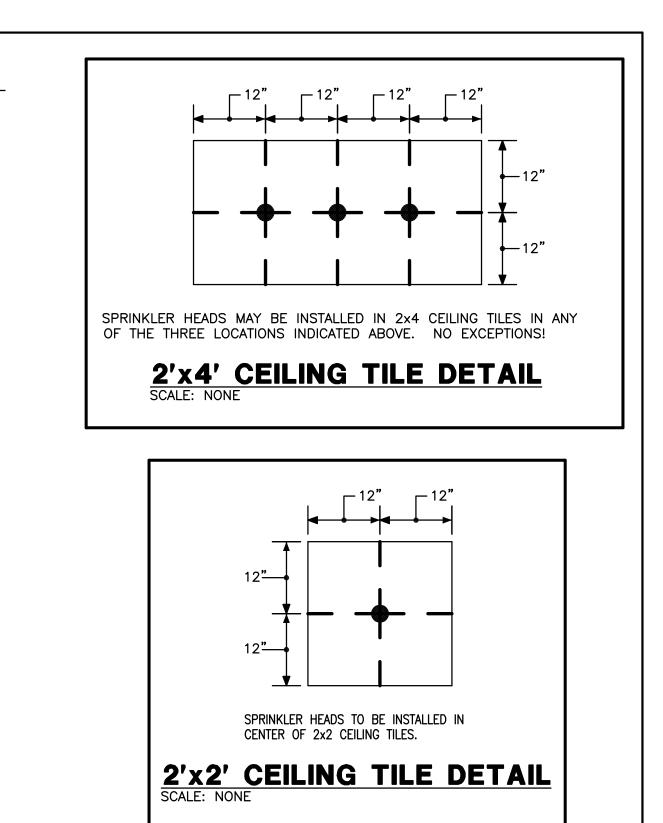

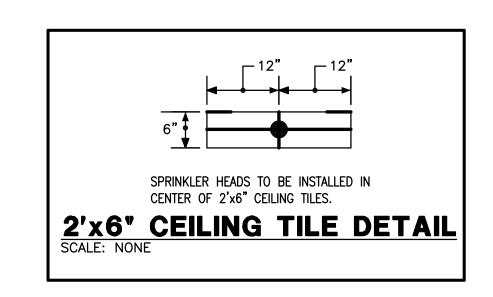

# PHASING NOTE:

THIS PROJECT INTERFACES EXTENSIVELY WITH EXISTING BUILDING SERVICES. IT SHALL BE THE CONTRACTOR'S RESPONSIBILITY TO COORDINATE AND PHASE ALL TIE-INS AND INTERRUPTIONS OF EXISTING SERVICES TO MINIMIZE OR ELIMINATE DOWNTIME. AS AN EXAMPLE, MAIN GAS SERVICE, WATER SERVICE, ELECTRICAL SERVICE, HVAC SERVICES, STEAM GENERATION, ETC., WILL BE AFFECTED AND REPLACED OR MOVED DURING THIS PROJECT. THE CONTRACTOR SHALL INSTALL ALL NEW SERVICES AND EQUIPMENT AND HAVE THEM TESTED AND FULLY AND RELIABLY FUNCTIONAL PRIOR TO INTERRUPTING, RELOCATING OR REMOVING ANY EXISTING SERVICES. IT SHALL BE THE CONTRACTOR'S RESPONSIBILITY TO BARE ANY AND ALL COSTS ASSOCIATED WITH THIS PHASING, INCLUDING TEMPORARY SERVICES, TEMPORARY RELOCATION, PREMIUM TIME WORK, ETC. CONTRACTOR SHALL COORDINATE ALL SAID WORK WITH THE OWNER AND APPLICABLE UTILITIES PER THE CONTRACT DOCUMENTS.

TEMPERATURE SENSOR

WORK IN CONFINED AREAS SHALL BE IN ACCORDANCE WITH THE OWNER'S SAFETY POLICY REQUIREMENTS.

# HAZARDOUS MATERIAL NOTE:

THE CONTRACTOR IT IS HEREBY ADVISED THAT IS POSSIBLE THAT ASBESTOS AND/OR OTHER HAZARDOUS MATERIALS ARE OR WERE PRESENT IN THIS BUILDING(S). ANY WORKER, OCCUPANT, VISITOR, ETC., WHO ENCOUNTERS ANY MATERIAL OF WHOSE CONTENT THEY ARE NOT CERTAIN SHALL PROMPTLY REPORT THE EXISTENCE AND LOCATION OF THAT MATERIAL TO THE OWNER. FURTHERMORE, THE CONTRACTOR SHALL INSURE THAT NO ONE COMES NEAR TO OR IN CONTACT WITH ANY SUCH MATERIAL OR FUMES THEREFROM UNTIL ITS CONTENT CAN BE ASCERTAINED TO BE NON-HAZARDOUS.

CMTA. INC. HAS NO EXPERTISE IN THE DETERMINATION OF THE PRESENCE OF ANY HAZARDOUS MATERIAL. THEREFORE, NO ATTEMPT HAS BEEN MADE BY CMTA TO IDENTIFY THE EXISTENCE OR LOCATION OF ANY SUCH HAZARDOUS MATERIAL. FURTHERMORE, CMTA NOR ANY AFFILIATE HEREOF WILL NOT OFFER OR MAKE ANY RECOMMENDATIONS RELATIVE TO THE REMOVAL, HANDLING OR DISPOSAL OF SUCH MATERIAL.

IF THE WORK WHICH IS TO BE PERFORMED INTERFACES, CONNECTS OR RELATES IN ANY PHYSICAL WAY WITH OR TO EXISTING COMPONENTS WHICH CONTAIN OR BEAR ANY HAZARDOUS MATERIAL, ASBESTOS BEING ONE, THEN IT SHALL BE THE CONTRACTOR'S SOLE RESPONSIBILITY TO CONTACT THE OWNER AND SO ADVISE HIM IMMEDIATELY.

THE CONTRACTOR BY EXECUTION OF THE CONTRACT FOR ANY WORK AND/OR BY THE ACCOMPLISHMENT OF ANY WORK THEREBY AGREE TO BRING NO CLAIM RELATIVE TO HAZARDOUS MATERIALS FOR NEGLIGENCE, BREACH OF CONTRACT, INDEMNITY, OR ANY OTHER SUCH ITEM AGAINST CMTA, ITS PRINCIPALS, EMPLOYEES, AGENTS OR CONSULTANTS. ALSO, THE CONTRACTOR FURTHER AGREES TO DEFEND, INDEMNIFY AND HOLD CMTA, ITS PRINCIPALS, EMPLOYEES, AGENTS AND CONSULTANTS HARMLESS FROM ANY SUCH RELATED CLAIMS WHICH MAY BE BROUGHT BY ANY SUBCONTRACTORS, SUPPLIERS OR ANY OTHER THIRD PARTIES.

THE CONTRACTOR IS DIRECTED TO THE SPECIFICATIONS FOR FURTHER INFORMATION.

# FIRE PROTECTION NOTES:

- 1. ALL AREAS SHALL BE PROTECTED BY A 100% WET PIPE FIRE SUPPRESSION SYSTEM INSTALLED IN STRICT ACCORDANCE WITH NFPA-13, THE KENTUCKY BUILDING CODES AND THE PROJECT SPECIFICATIONS.
- 2. REFER TO A COMPLETE SET OF DOCUMENTS (ARCHITECTURAL, STRUCTURAL, MECHANICAL AND ELECTRICAL PLANS AND SPECIFICATIONS) FOR COORDINATION OF TRADES, ROOMS, STRUCTURE AND EQUIPMENT.
- . WHERE CEILINGS ARE INDICATED ALL SPRINKLER PIPING MUST BE INSTALLED ABOVE CEILINGS. SPRINKLER PIPING MUST BE COORDINATED WITH OTHER TRADES PIPING MUST BE OFFSET TO AVOID CONFLICTS WITH DUCTWORK, CONDUIT, ALL EQUIPMENT, ETC.
- 4. INSTALL HEADS IN CENTER OF 2' X 2' TILES. INSTALL HEADS ON 1/4 POINTS OF THE 4' DIMENSION AND CENTER OF THE 2' DIMENSION IN 2' X 4' TILES. DO NOT MOUNT HEADS IN CENTER OF 2' X 4' TILE IF IT IS SCORED TO LOOK LIKE TWO 2' X 2' TILES.
- 5. ALL FIRE PROTECTION PIPE SIZES SHALL BE HYDRAULICALLY CALCULATED IN ACCORDANCE WITH NFPA-13.
- 6. ALL SPRINKLER HEADS SHALL BE QUICK RESPONSE SPRINKLER HEADS.
- 7. THE FIRE PROTECTION CONTRACTOR SHALL PERFORM HIS OWN FLOW TEST PRIOR TO SUBMITTING SHOP DRAWINGS.

STATIC PSI: 110 RESIDUAL PSI: 80


FLOW DATA


FLOW: 2550 GPM DURATION: 2 MIN DATE & TIME: 07-09-2013 AT 1:45 PM

SOURCE OF WATER: KENTUCKY AMERICAN WATER SOURCE OF DATA: KENTUCKY AMERICAN WATER FIRE FLOW TEST REPORT

HAZARD: LIGHT & ORDINARY OCCUPANCY OF BUILDING: OFFICE

> REVISIONS DATE COUNCIL OF STATE GOVERNMENTS - HEADQUARTERS BUILDING 2760 RESEARCH PARK DRIVE LEXINGTON, KY 40511 DRAWING NO PLUMBING LEGEND **NOV. 2013** DRAWN BY COMMONWEALTH OF KENTUCKY FINANCE AND ADMINISTRATION CABINET ISION OF ENGINEERING & CONTRACT ADMINISTRATION CHECKED BY DEPARTMENT FOR FACILITIES AND SUPPORT SERVICES CMR FRANKFORT, KENTUCKY A & E FILE NC REVIEWED DIV. OF ENGR. 1302.00 212 North Upper Street Lexington, Kentucky 40507-1001 p 859.252.6664 f 859.253.2358 CSG13 ARCHITECTS www.omniarchitects.com ENGR. FILE NO **NOV. 2013** 785-C6BR-BC01-00 ITHORIZED AGENT APPROVED FOR PROGRAM CONCEPT ONLY DIVISION OF ENGINEERING
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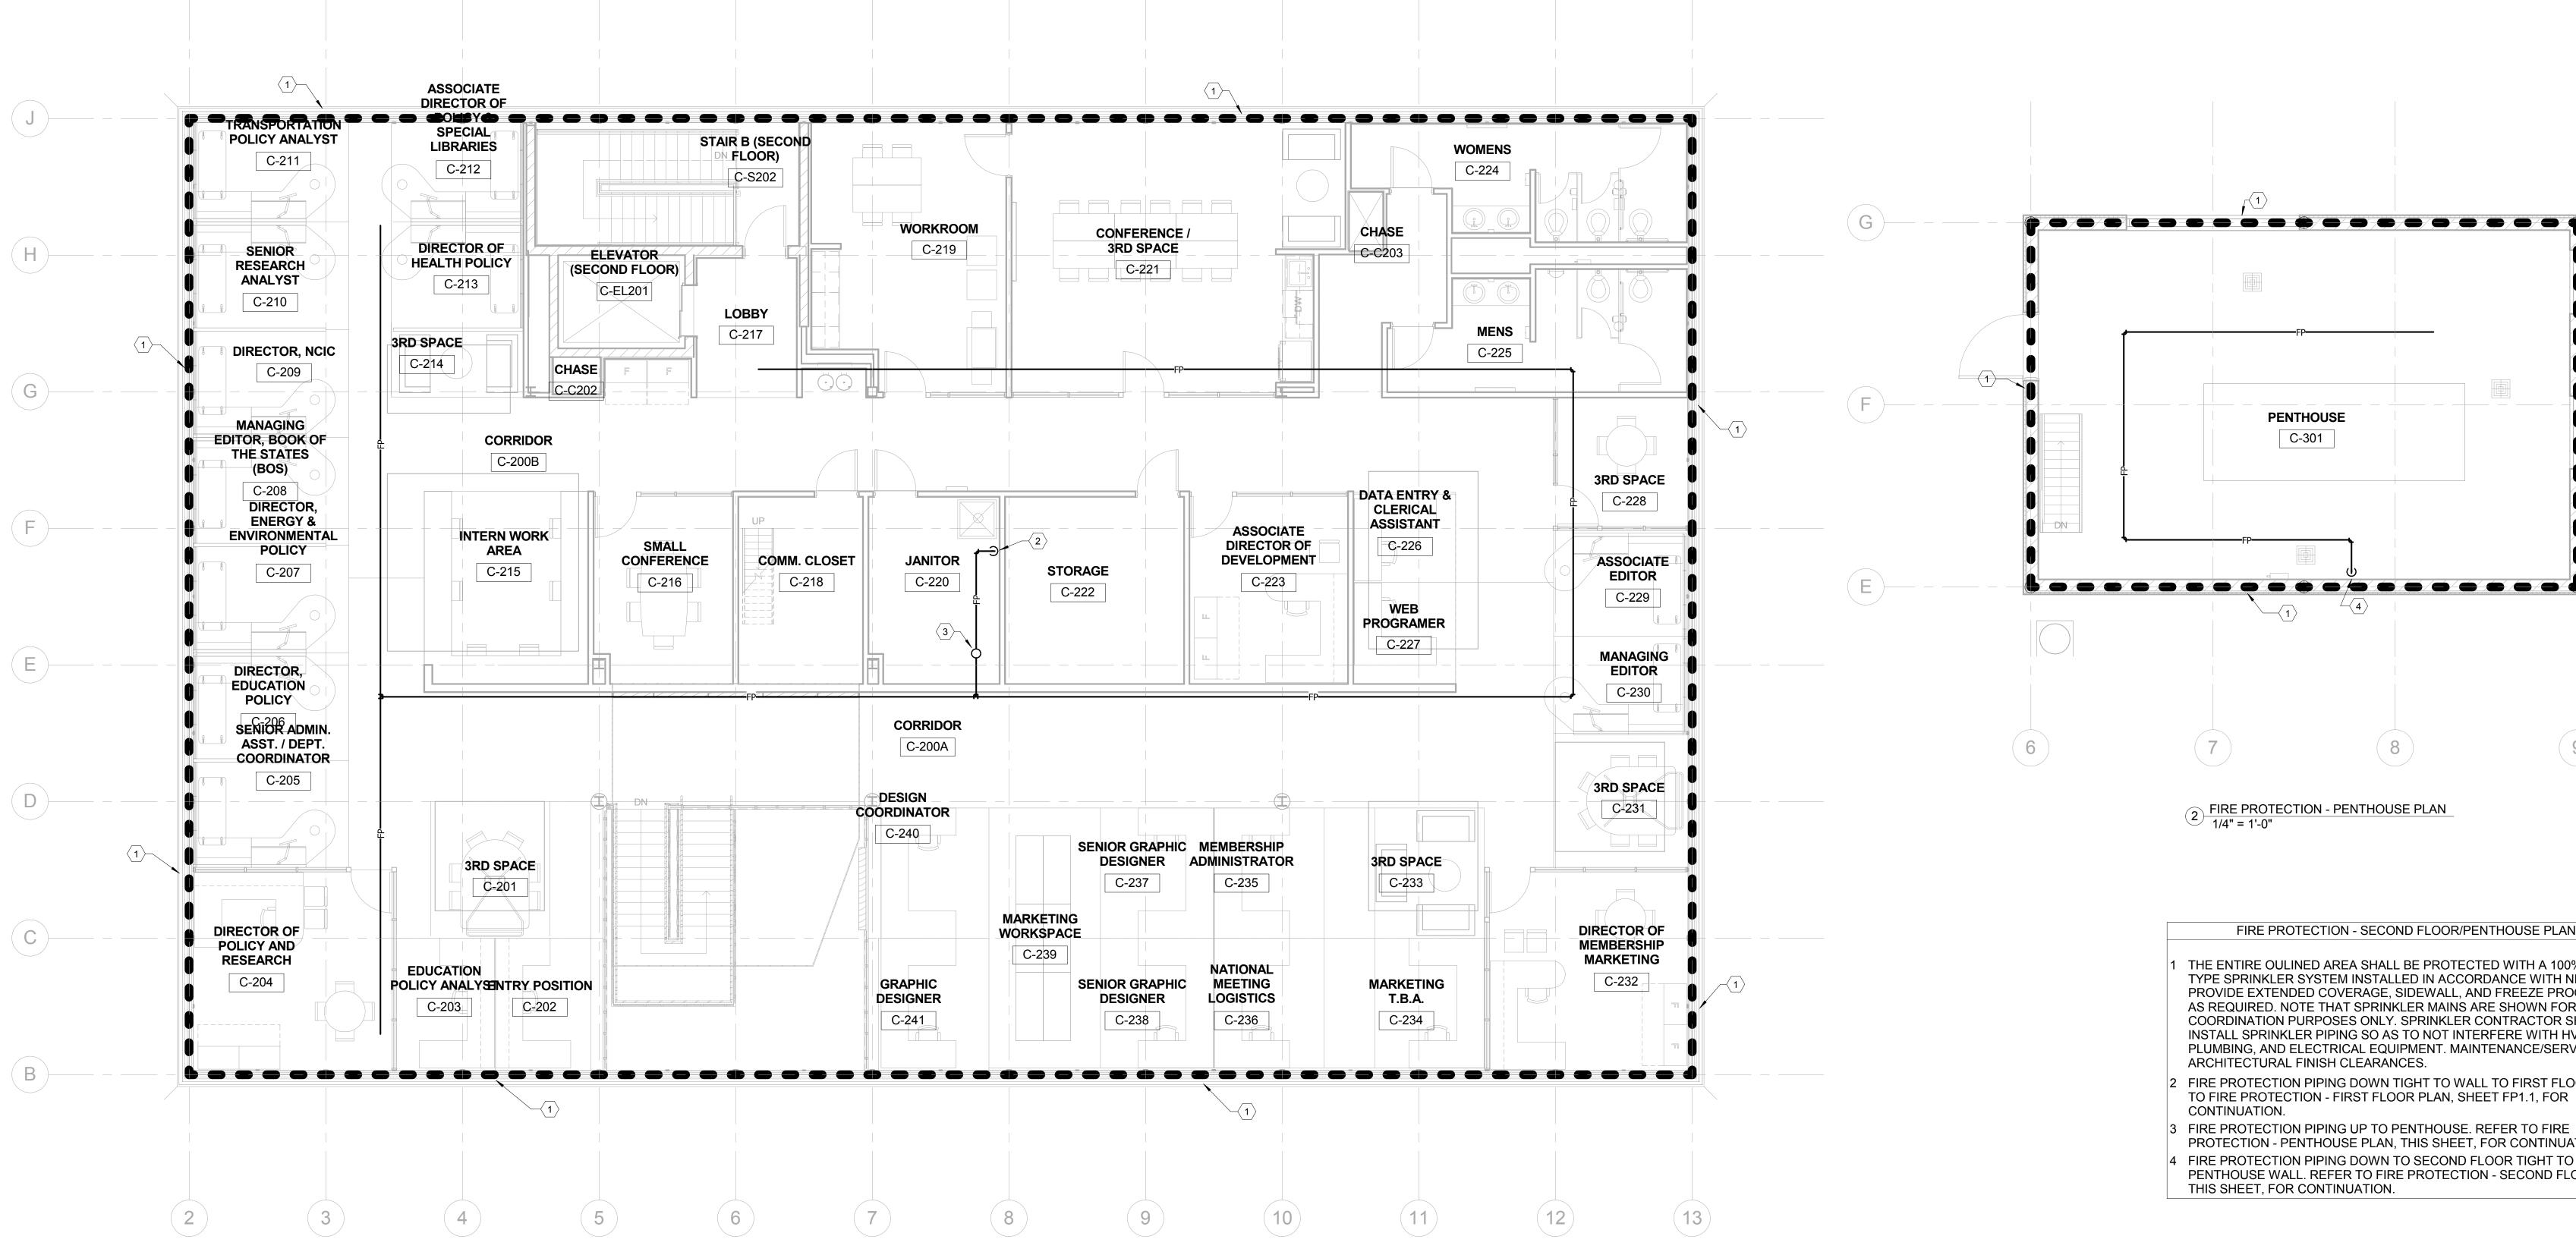
1 FIRE PROTECTION - FIRST FLOOR PLAN 3/16" = 1'-0"

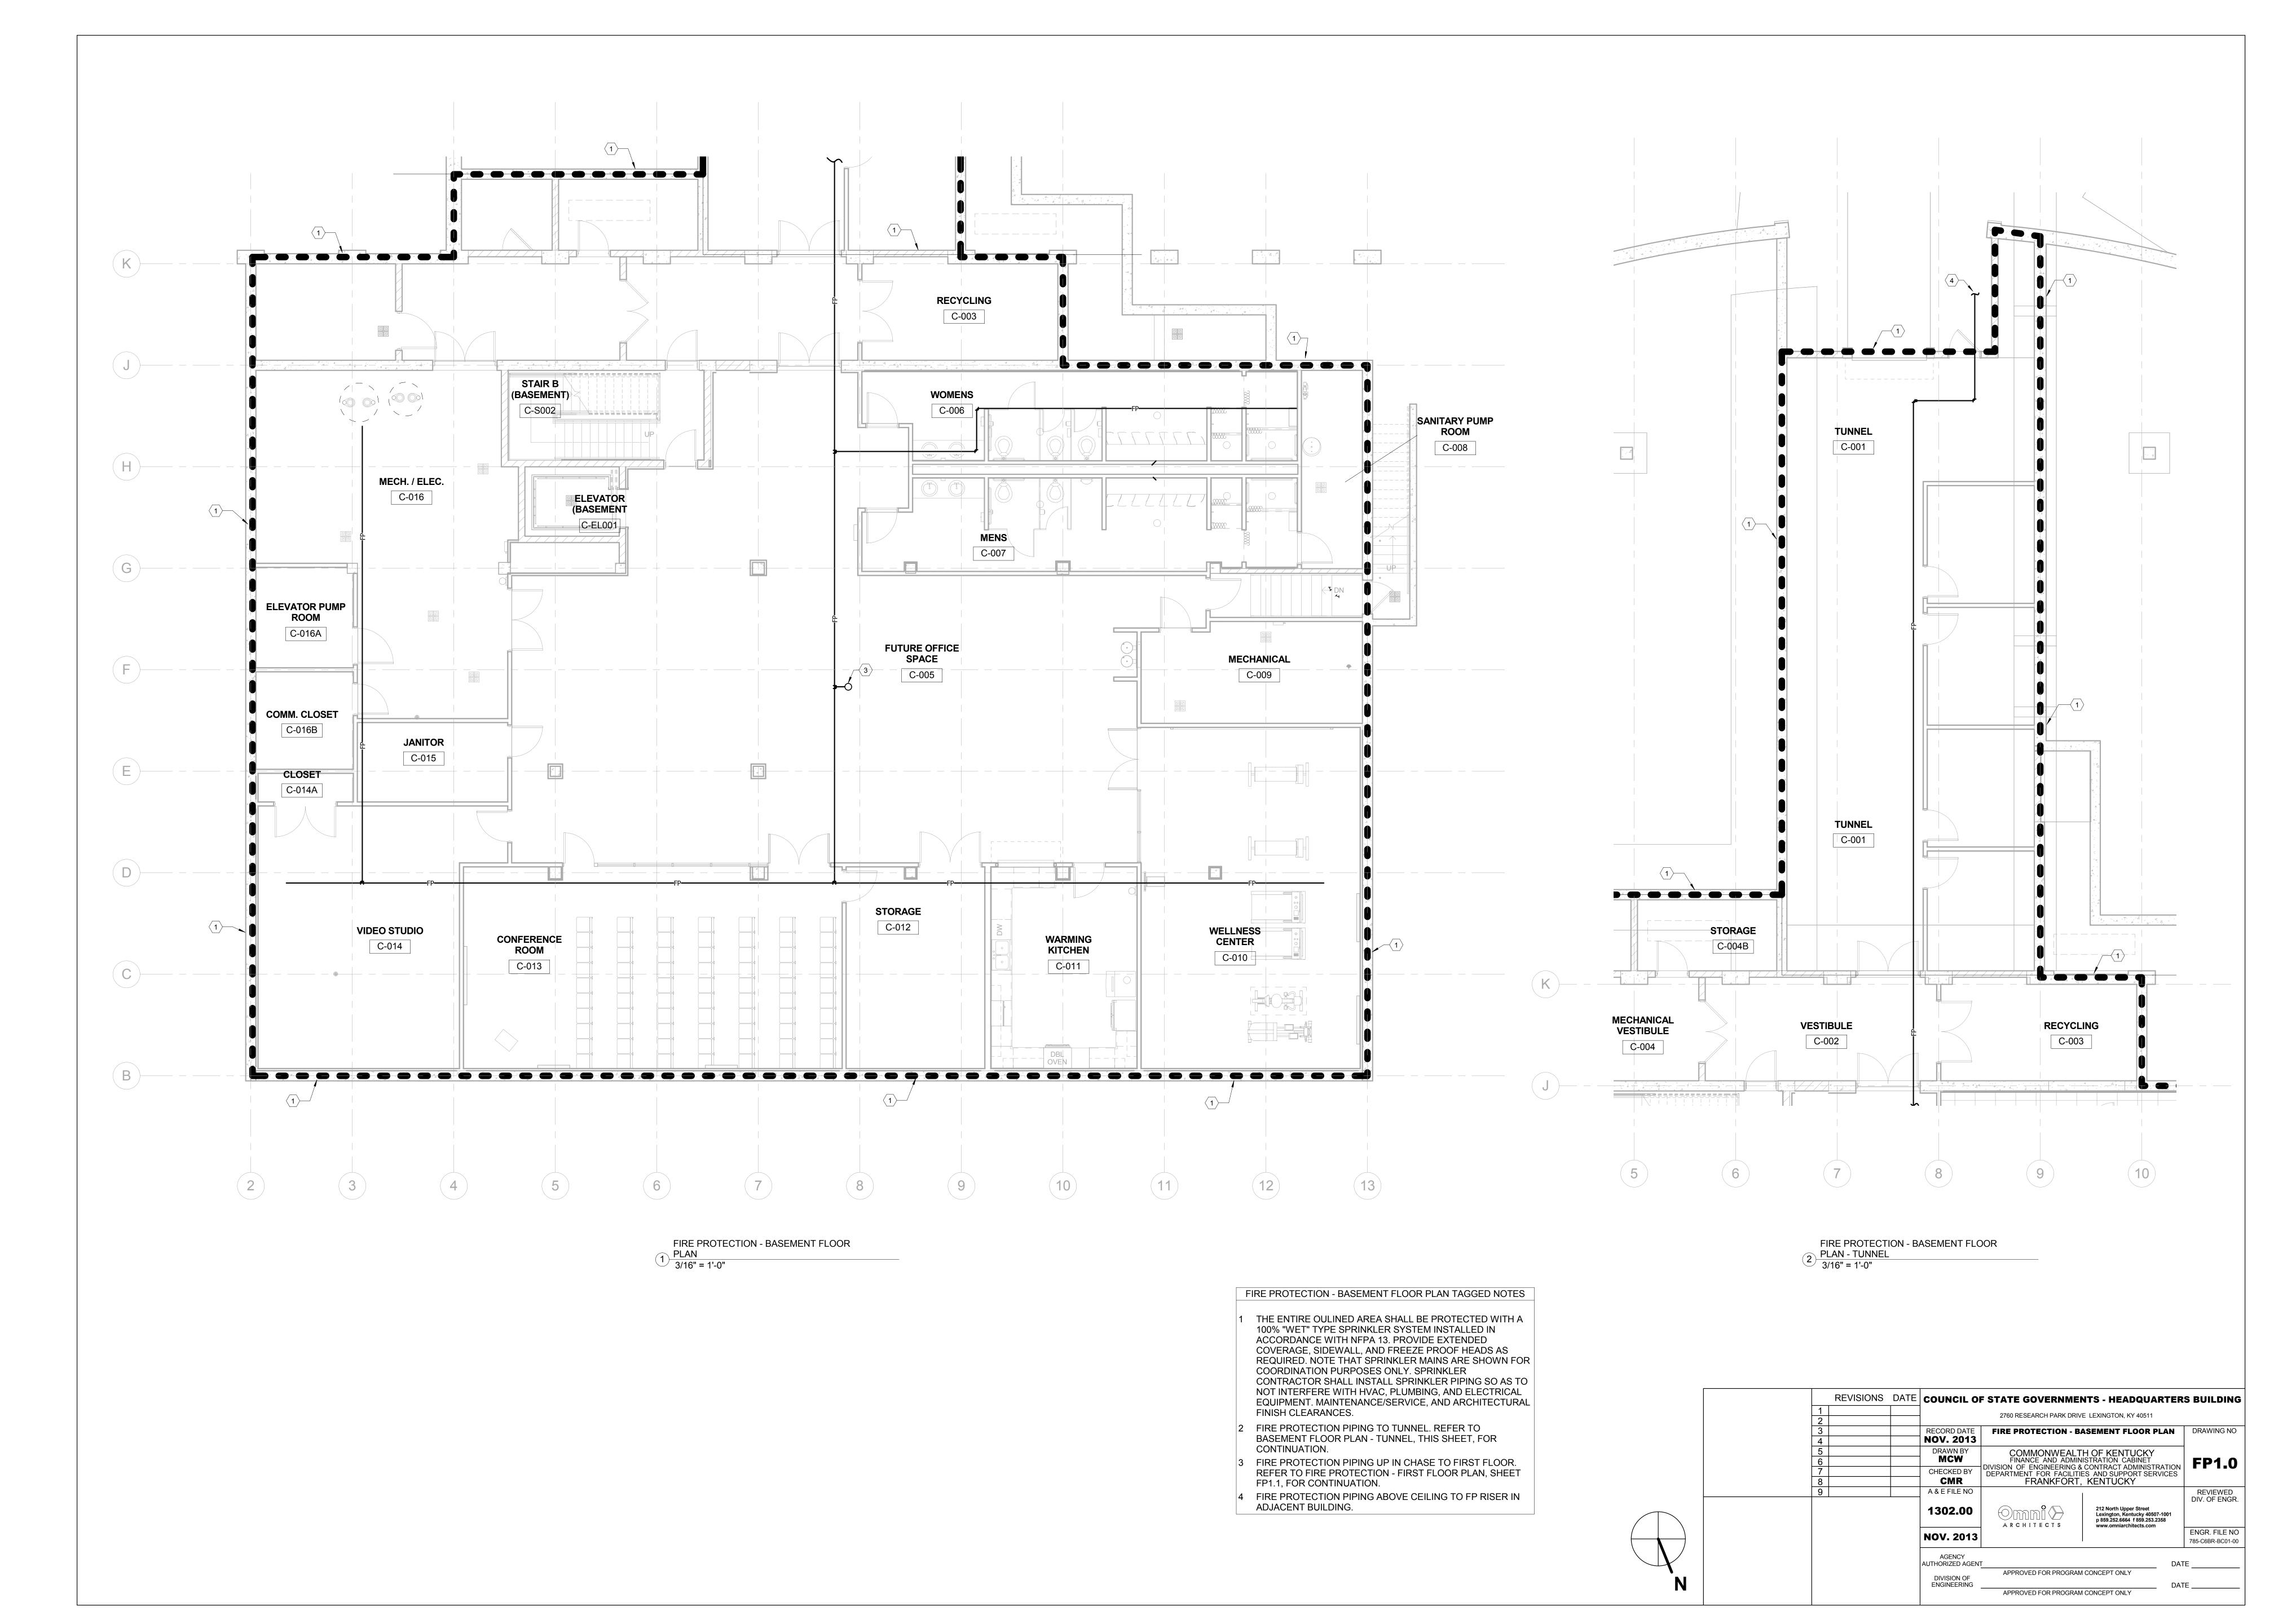
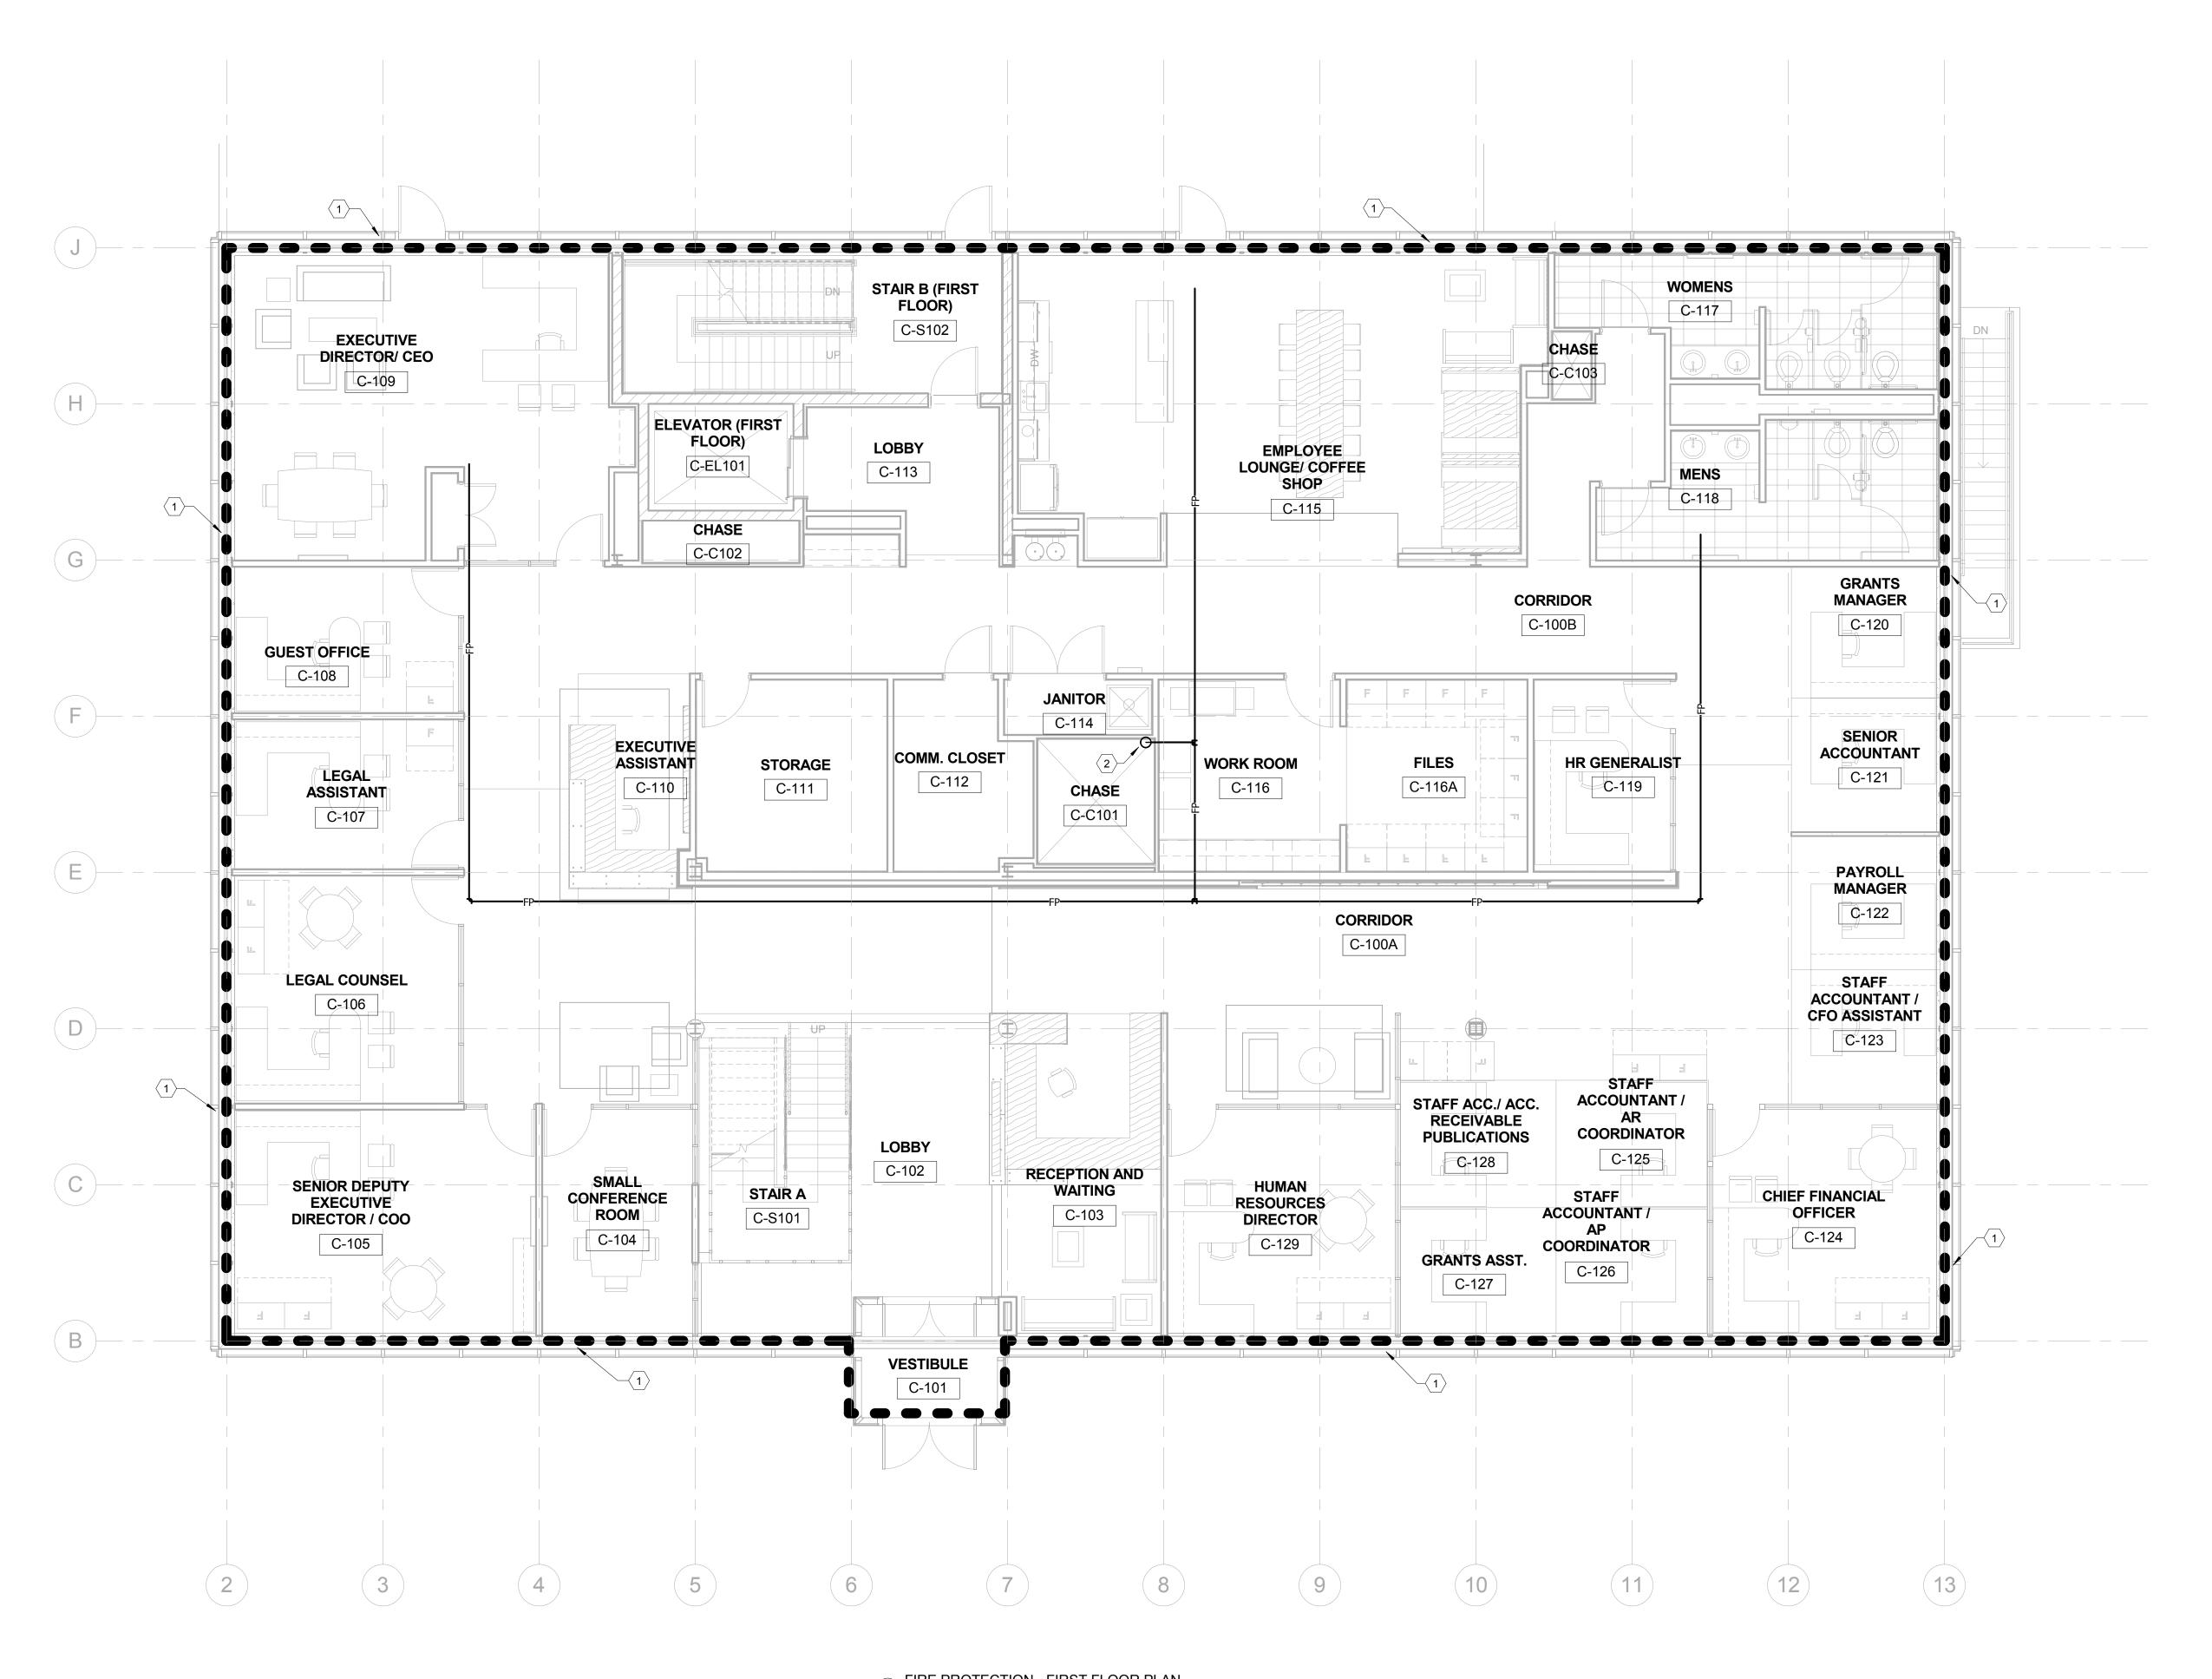
#### FIRE PROTECTION - FIRST FLOOR PLAN

- 1 THE ENTIRE OULINED AREA SHALL BE PROTECTED WITH A 100% "WET" TYPE SPRINKLER SYSTEM INSTALLED IN ACCORDANCE WITH NFPA 13. PROVIDE EXTENDED COVERAGE, SIDEWALL, AND FREEZE PROOF HEADS AS REQUIRED. NOTE THAT SPRINKLER MAINS ARE SHOWN FOR COORDINATION PURPOSES ONLY. SPRINKLER CONTRACTOR SHALL INSTALL SPRINKLER PIPING SO AS TO NOT INTERFERE WITH HVAC, PLUMBING, AND ELECTRICAL EQUIPMENT. MAINTENANCE/SERVICE, AND ARCHITECTURAL FINISH CLEARANCES.
- 2 FIRE PROTECTION PIPING UP AND DOWN. REFER TO FIRE PROTECTION BASEMENT FLOOR PLAN, SHEET FP1.0, AND FIRE PROTECTION SECOND FLOOR PLAN, SHEET FP1.2, FOR CONTINUATION.

		REVISIONS	DATE	COUNCIL O	F STATE GOVERNME	NTS - HEADQUARTER	S BUILDING	
	1				2760 RESEARCH PARK DRIV	E LEXINGTON, KY 40511		
	3			RECORD DATE NOV. 2013	FIRE PROTECTION	FIRST FLOOR PLAN	DRAWING NO	
	4 5 6			DRAWN BY MCW	COMMONWEALT FINANCE AND ADMIN	H OF KENTUCKY	FP1.1	
	7			CHECKED BY Checker	DIVISION OF ENGINEERING &	CONTRACT ADMINISTRATION ES AND SUPPORT SERVICES		
	9			A & E FILE NO	,		REVIEWED DIV. OF ENGR.	
				1302.00		212 North Upper Street Lexington, Kentucky 40507-1001 p 859.252.6664 f 859.253.2358 www.omniarchitects.com		
				NOV. 2013			ENGR. FILE NO 785-C6BR-BC01-00	
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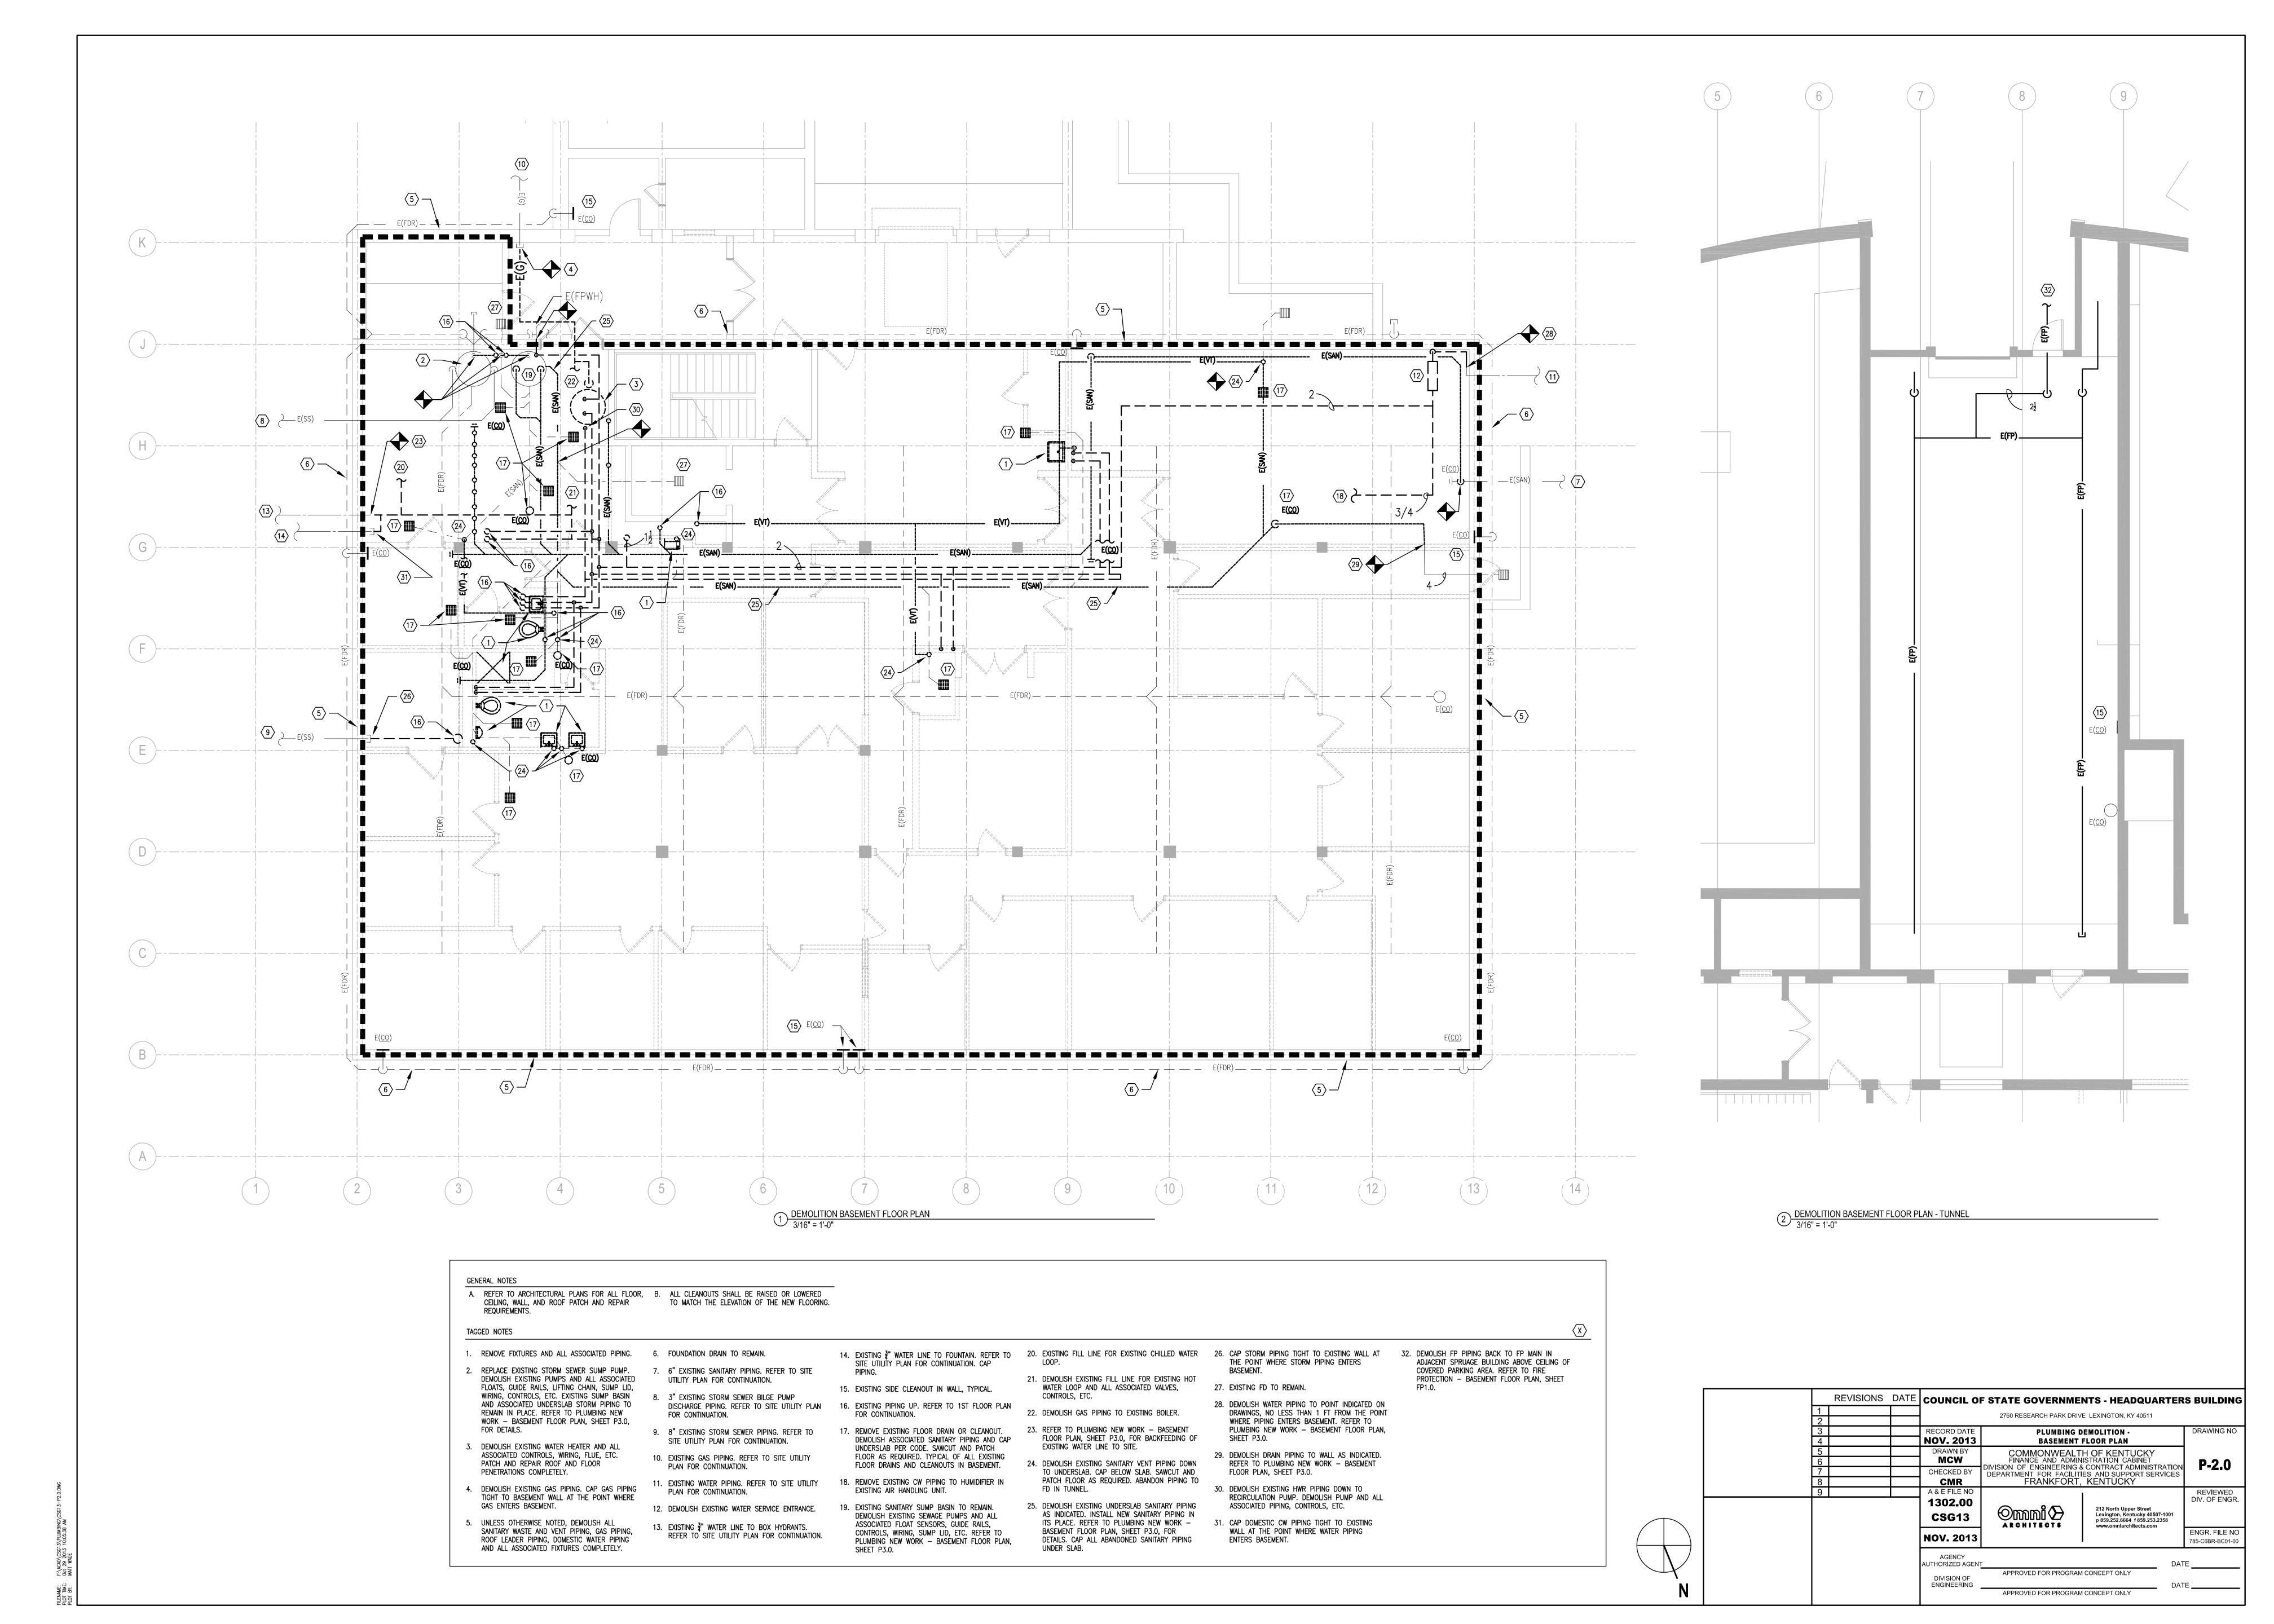
FIRE PROTECTION - SECOND FLOOR


1 PLAN 3/16" = 1'-0"

FIRE PROTECTION - SECOND FLOOR/PENTHOUSE PLAN

- THE ENTIRE OULINED AREA SHALL BE PROTECTED WITH A 100% "WET" TYPE SPRINKLER SYSTEM INSTALLED IN ACCORDANCE WITH NFPA 13. PROVIDE EXTENDED COVERAGE, SIDEWALL, AND FREEZE PROOF HEADS AS REQUIRED. NOTE THAT SPRINKLER MAINS ARE SHOWN FOR COORDINATION PURPOSES ONLY. SPRINKLER CONTRACTOR SHALL INSTALL SPRINKLER PIPING SO AS TO NOT INTERFERE WITH HVAC, PLUMBING, AND ELECTRICAL EQUIPMENT. MAINTENANCE/SERVICE, AND
- 2 FIRE PROTECTION PIPING DOWN TIGHT TO WALL TO FIRST FLOOR. REFER TO FIRE PROTECTION - FIRST FLOOR PLAN, SHEET FP1.1, FOR
- PROTECTION PENTHOUSE PLAN, THIS SHEET, FOR CONTINUATION.
- 4 FIRE PROTECTION PIPING DOWN TO SECOND FLOOR TIGHT TO PENTHOUSE WALL. REFER TO FIRE PROTECTION - SECOND FLOOR PLAN,

REVISIONS DATE COUNCIL OF STATE GOVERNMENTS - HEADQUARTERS BUILDING 2760 RESEARCH PARK DRIVE LEXINGTON, KY 40511 DRAWING NO FIRE PROTECTION - SECOND RECORD DATE NOV. 2013 FLOOR/PENTHOUSE PLAN COMMONWEALTH OF KENTUCKY FINANCE AND ADMINISTRATION CABINET MCW FINANCE AND ADMINISTRATION CABINET ISION OF ENGINEERING & CONTRACT ADMINISTRATION FP1.2 CHECKED BY DEPARTMENT FOR FACILITIES AND SUPPORT SERVICES **CMR** FRANKFORT, KENTUCKY A & E FILE NO REVIEWED DIV. OF ENGR. 212 North Upper Street Lexington, Kentucky 40507-1001 p 859.252.6664 f 859.253.2358 1302.00 ARCHITECTS www.omniarchitects.com ENGR. FILE NO **NOV. 2013** 785-C6BR-BC01-00 AUTHORIZED AGENT APPROVED FOR PROGRAM CONCEPT ONLY DIVISION OF ENGINEERING \_\_\_\_\_\_\_APPROVED FOR PROGRAM CONCEPT ONLY



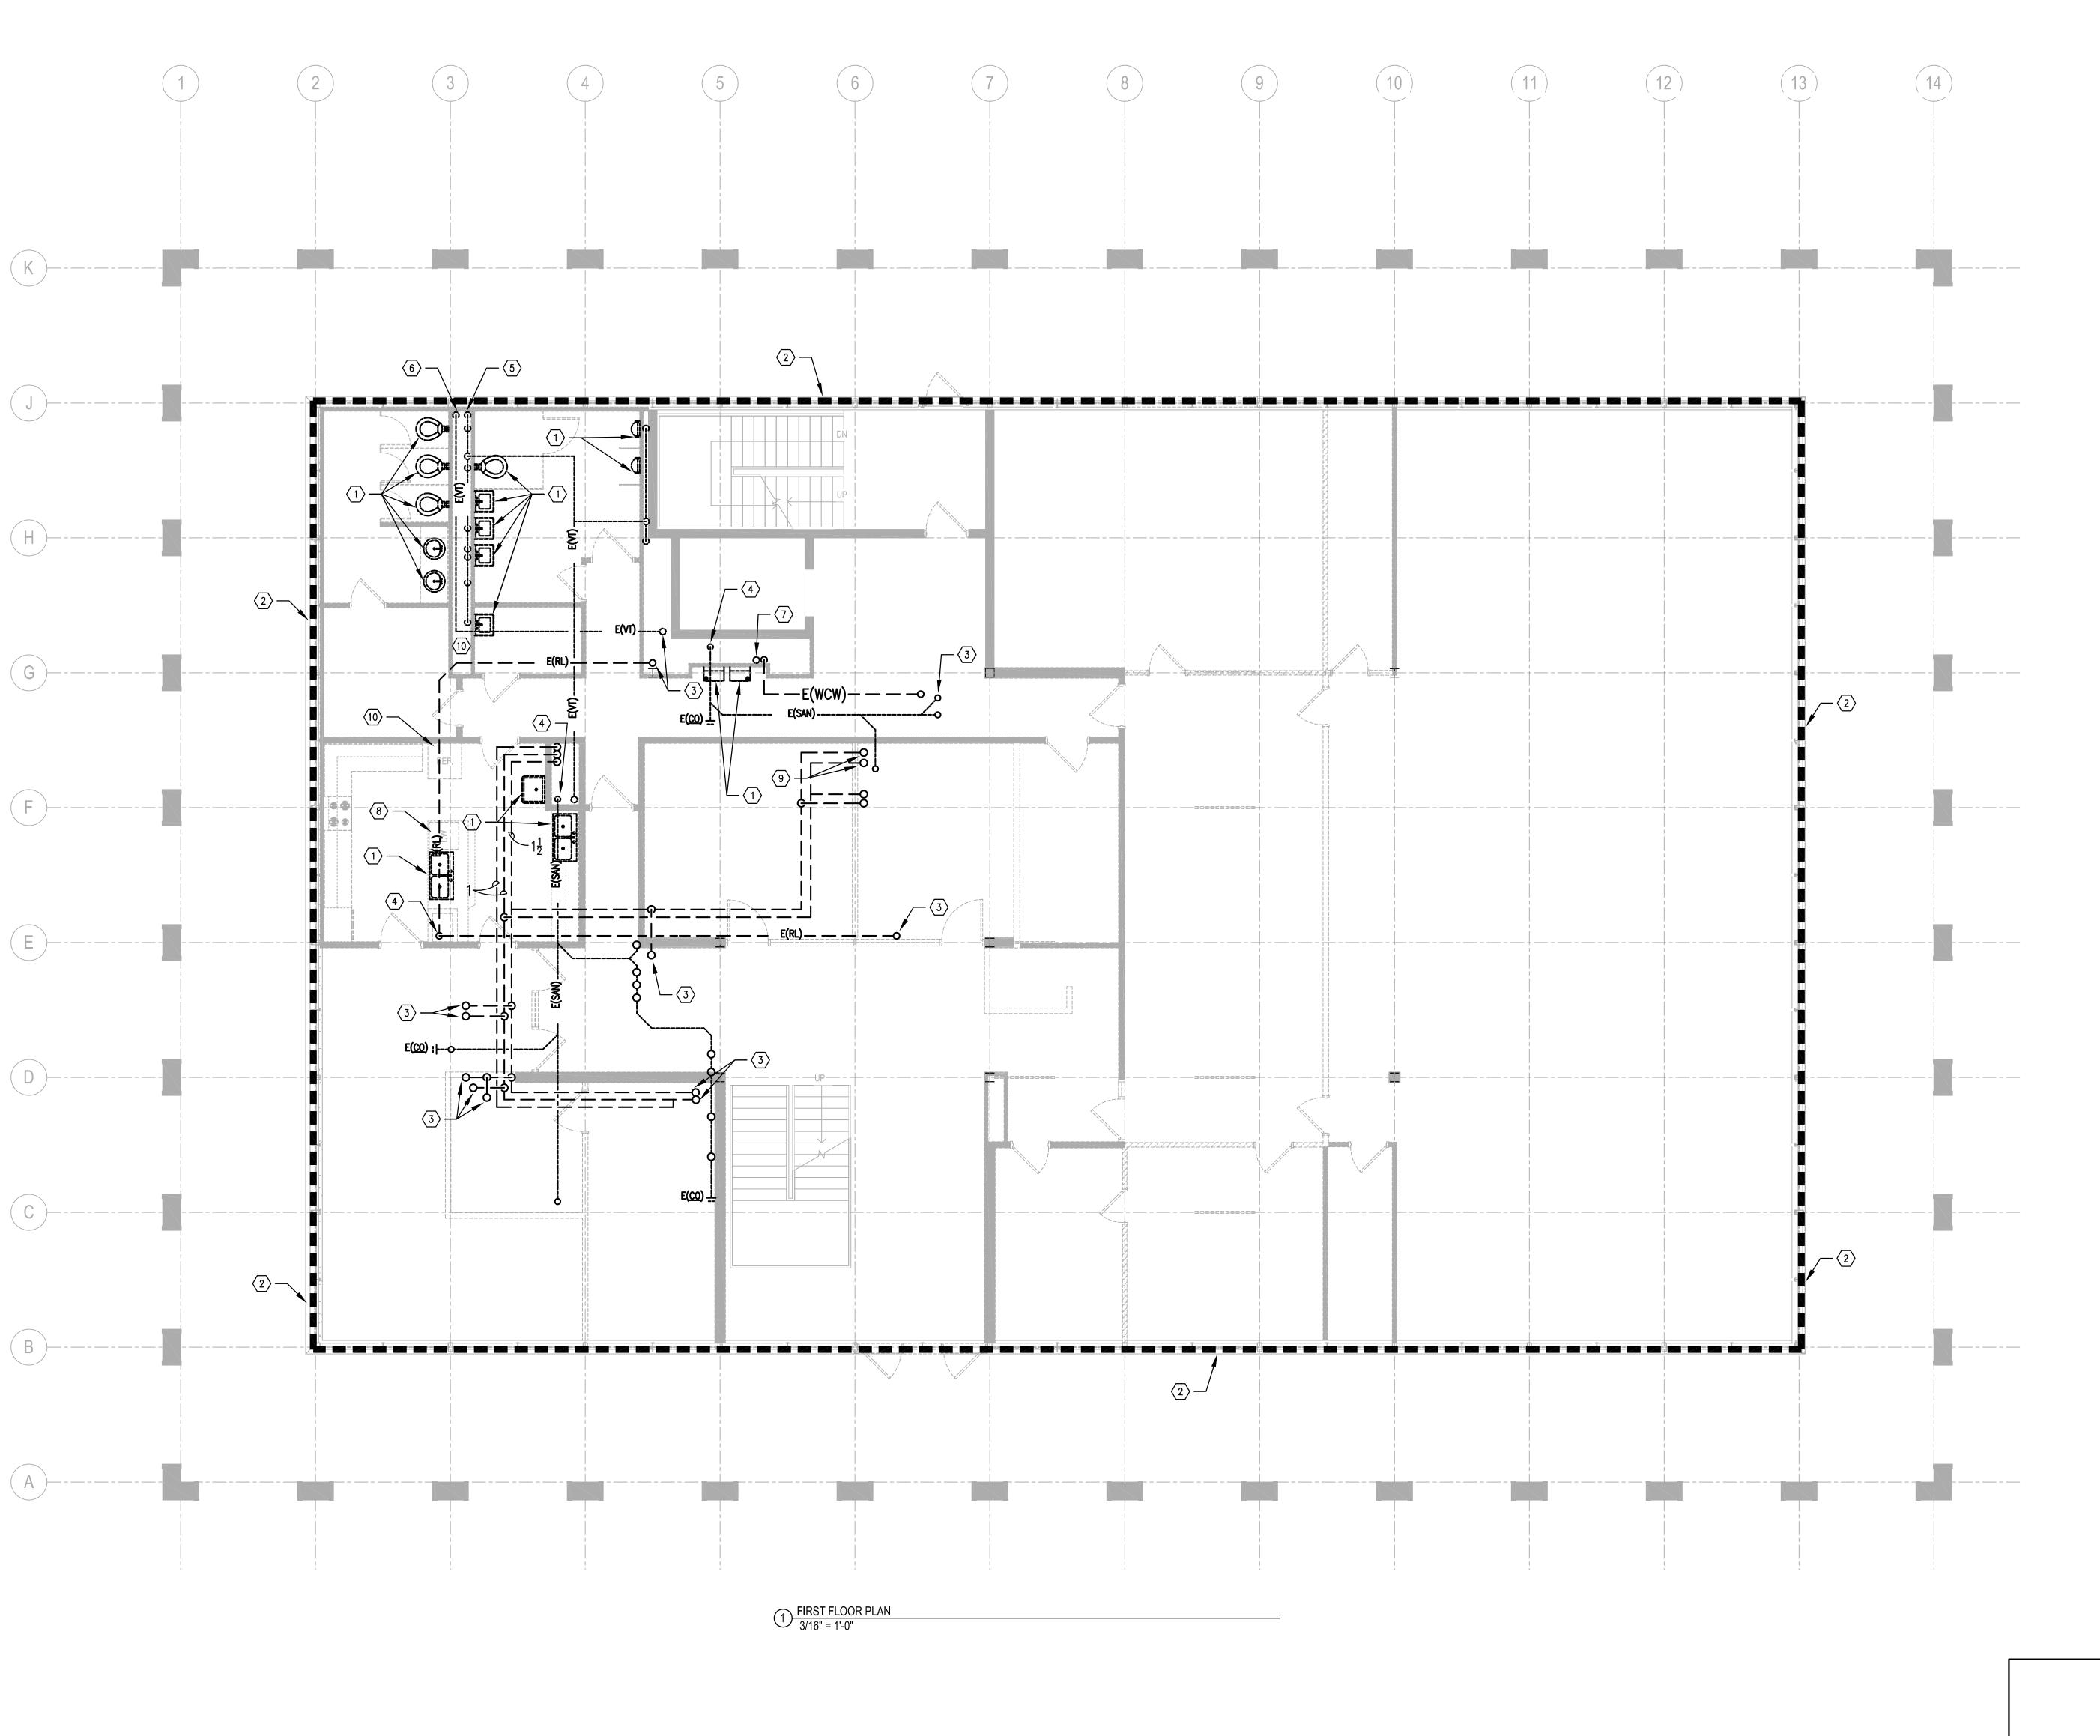


TAGGED NOTES:

- REMOVE EXISTING PLUMBING FIXTURES AND ALL ASSOCIATED
  PIPING
- 2. DEMOLISH ALL SANITARY WASTE AND VENT PIPING, GAS PIPING, DOMESTIC WATER PIPING AND ALL ASSOCIATED FIXTURES, ROOF LEADER PIPING COMPLETELY. REFER TO ARCHITECTURAL DRAWINGS FOR FLOOR, WALL, AND CEILING PATCH AND REPAIR REQUIREMENTS.
- 3. EXISTING PIPING UP TO 2ND FLOOR. REFER TO SECOND FLOOR PLUMBING DEMOLITION PLAN FOR CONTINUATION.
- 4. EXISTING PIPING DOWN TO BASEMENT BELOW. REFER TO BASEMENT PLUMBING DEMOLITION PLAN FOR CONTINUATION.
- 5. REMOVE 3" EXISTING SEWAGE PUMP VENT PIPING UP TO SECOND FLOOR AND DOWN TO BASEMENT.
- 6. REMOVE 3" EXISTING STORM BILGE PUMP VENT PIPING DOWN TO BASEMENT.
- 7. REMOVE EXISTING 4" VENT PIPING UP TO SECOND FLOOR AND DOWN TO BASEMENT. REFER TO SECOND FLOOR AND
- BASEMENT PLUMBING DEMOLITION PLAN FOR CONTINUATION.
- 8. REMOVE EXISTING DISHWASHER AND ASSOCIATED DRAIN, PIPING, AIR GAP, ETC. COMPLETELY.
- REMOVE HW/CW PIPING UP TO SECOND FLOOR FIXTURE. REFER TO 2ND FLOOR PLUMBING DEMOLITION PLAN FOR CONTINUATION.
- 10. REMOVE CW PIPING TO EXISTING REFRIGERATOR BACK TO CW

REVISIONS DATE COUNCIL OF STATE GOVERNMENTS - HEADQUARTERS BUILDING 2760 RESEARCH PARK DRIVE LEXINGTON, KY 40511 DRAWING NO PLUMBING DEMOLITION -FIRST FLOOR PLAN COMMONWEALTH OF KENTUCKY
FINANCE AND ADMINISTRATION CABINET
DIVISION OF ENGINEERING & CONTRACT ADMINISTRATION
DEPARTMENT FOR FACILITIES AND SUPPORT SERVICES
FRANKFORT, KENTUCKY DRAWN BY CHECKED BY CMR A & E FILE NO REVIEWED DIV. OF ENGR. 1302.00 212 North Upper Street Lexington, Kentucky 40507-1001 p 859.252.6664 f 859.253.2358 www.omnlarchltects.com CSG13 ENGR. FILE NO NOV. 2013 785-C6BR-BC01-00 AGENCY AUTHORIZED AGENT\_ APPROVED FOR PROGRAM CONCEPT ONLY DIVISION OF ENGINEERING DATE \_\_\_\_\_\_ DATE \_\_\_\_\_

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TAGGED NOTES:

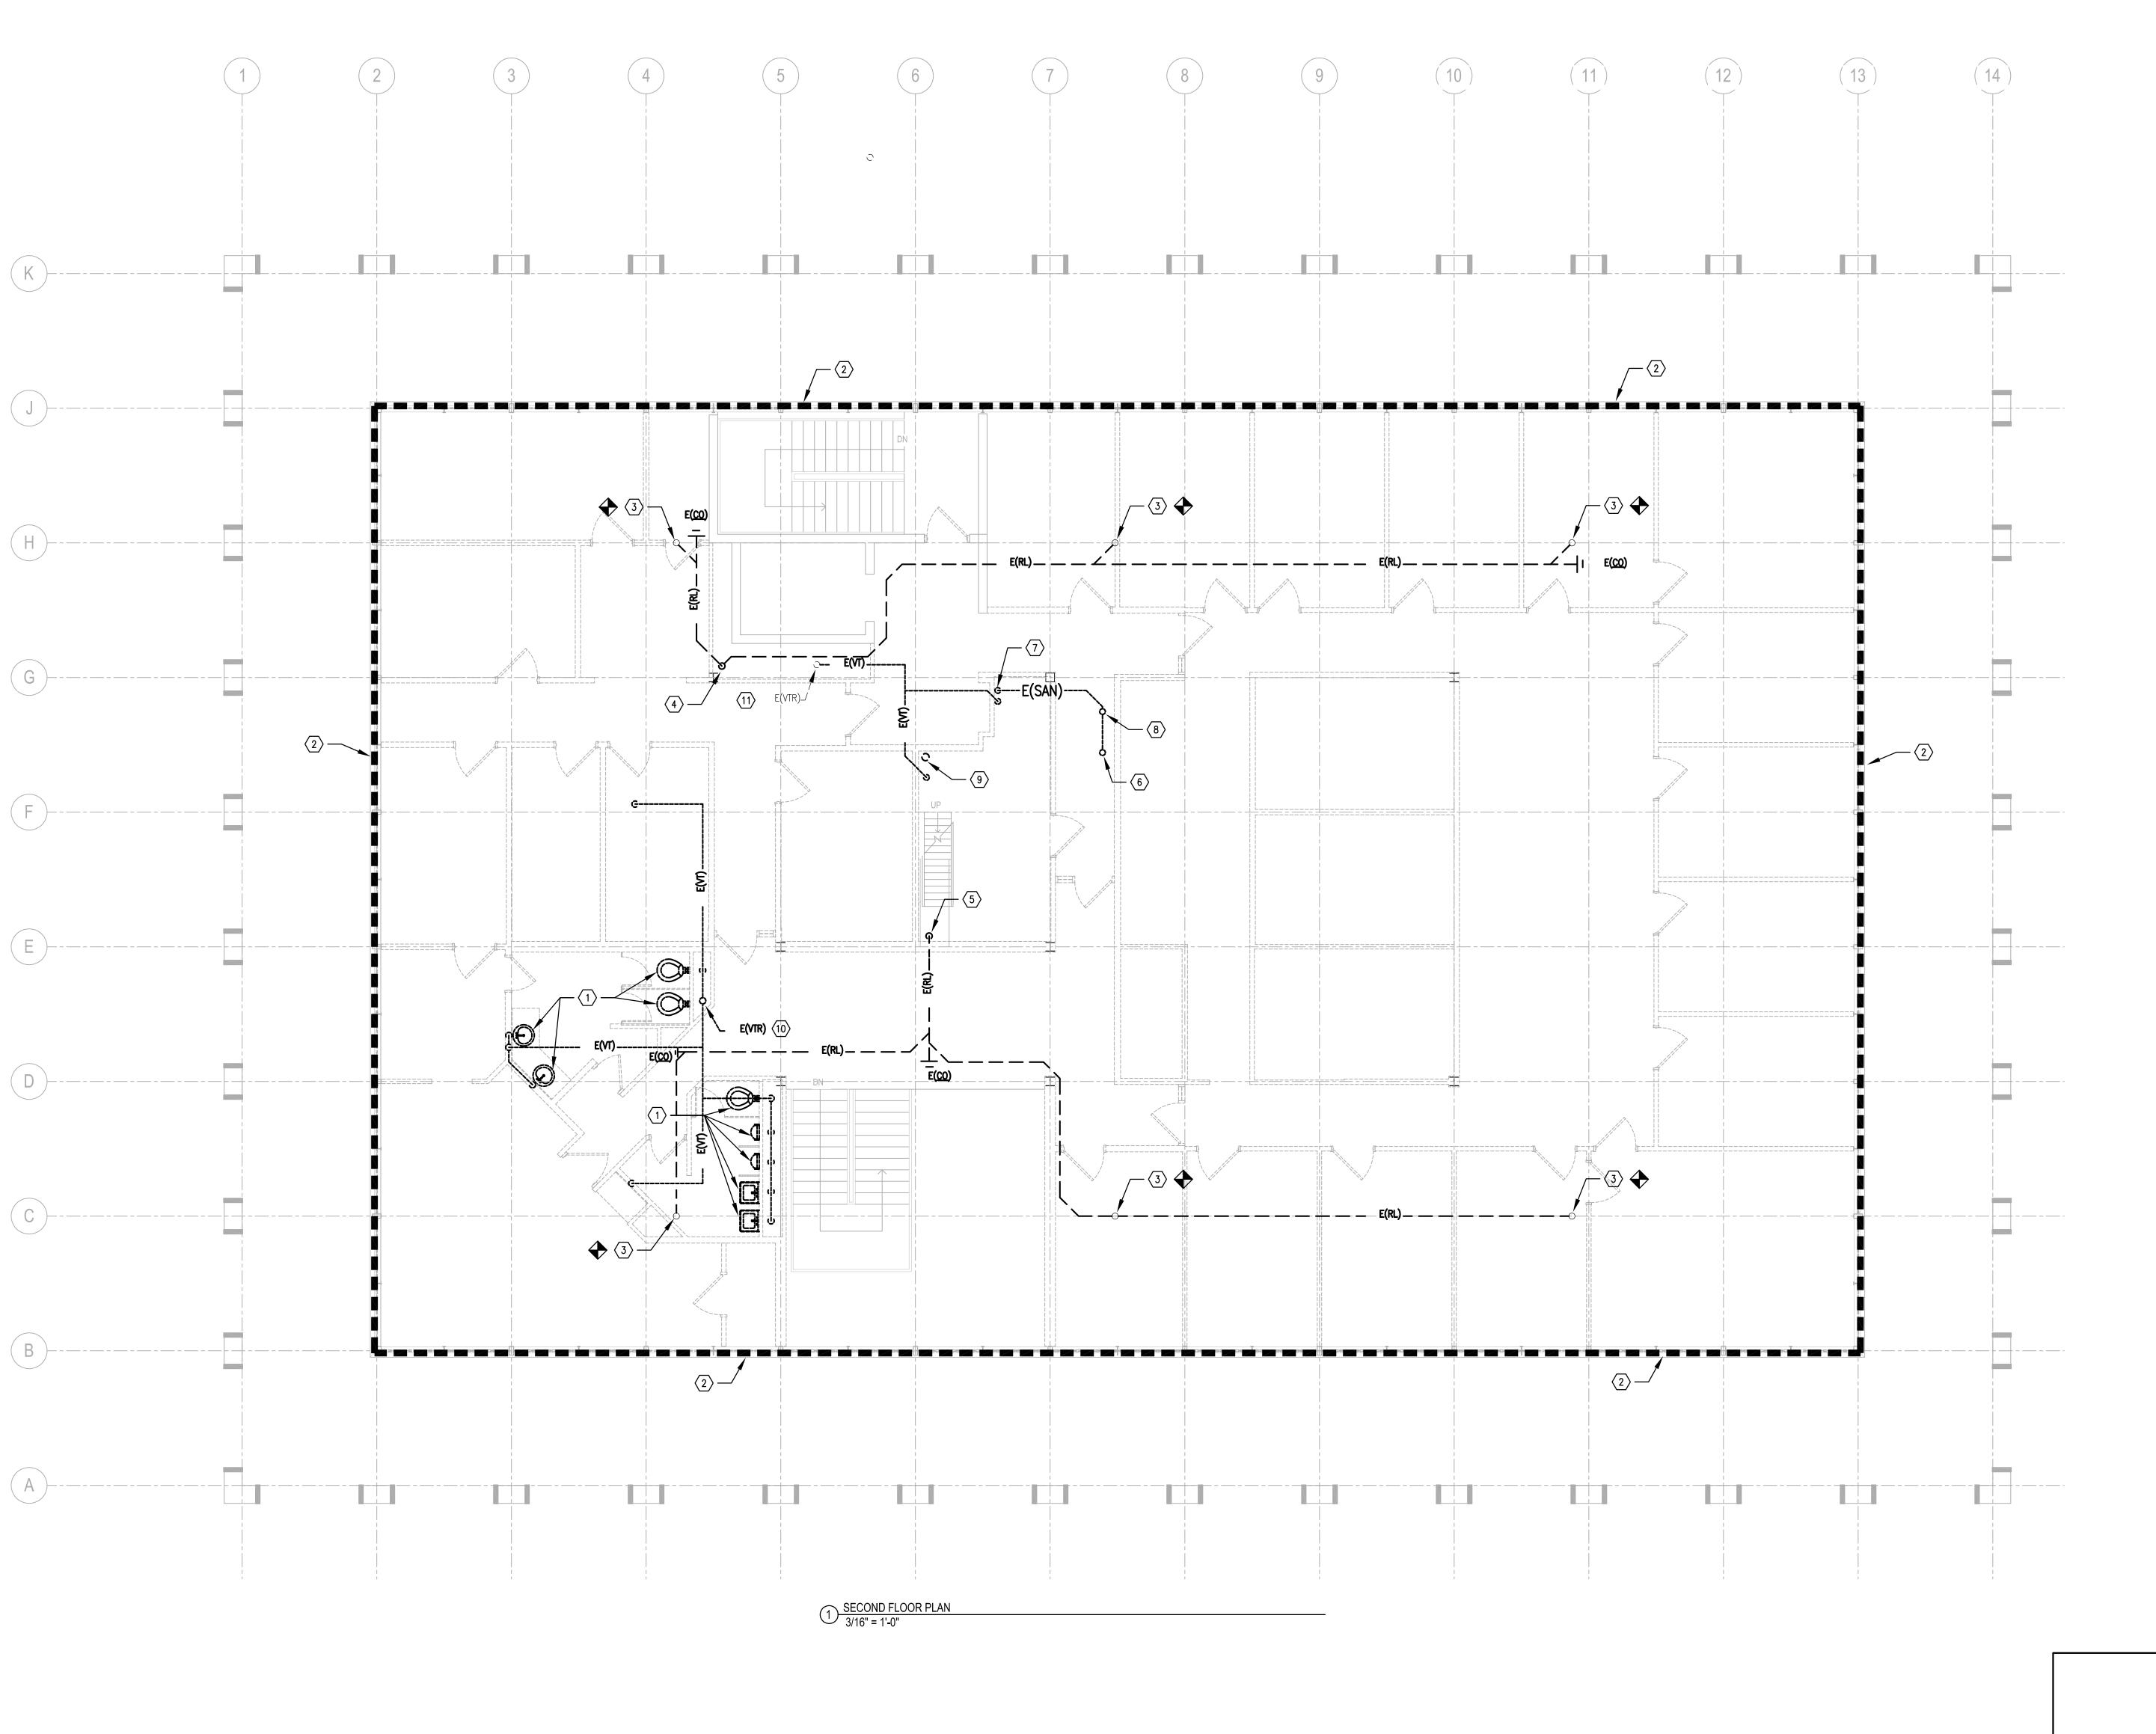1. REMOVE EXISTING PLUMBING FIXTURES AND ALL ASSOCIATED

- UNLESS OTHERWISE NOTED, DEMOLISH ALL SANITARY WASTE
   AND VENT PIPING, GAS PIPING, ROOF LEADER PIPING,
- DOMESTIC WATER PIPING AND ALL ASSOCIATED FIXTURES
  COMPLETELY. REFER TO ARCHITECTURAL DRAWINGS FOR WALL,
  CEILING, AND FLOOR PATCH AND REPAIR REQUIREMENTS.

  3. EXISTING ROOF LEADER PIPING UP TO ROOF DRAIN. ROOF
- DRAIN SHALL REMAIN. REPLACE ALL ROOF LEADER PIPING TO ROOF DRAIN. REFER TO PLUMBING NEW WORK SECOND FLOOR PLAN, SHEET P3.2 FOR CONTINUATION.

  4. REMOVE 5" EXISTING ROOF LEADER PIPING DOWN IN CHASE

TO FIRST FLOOR. REFER TO FIRST FLOOR PLUMBING

DEMOLITION PLAN FOR CONTINUATION.

- 5. REMOVE 6" EXISTING ROOF LEADER PIPING DOWN TO FIRST FLOOR. REFER TO FIRST FLOOR PLUMBING DEMOLITION PLAN FOR CONTINUATION. 3" EXISTING ROOF LEADER PIPING UP TO PENTHOUSE. DEMOLISH 3" ROOF LEADER PIPING TO THE POINT IT PENETRATES PENTHOUSE FLOOR ABOVE. REFER TO PENTHOUSE PLUMBING DEMOLITION PLAN FOR CONTINUATION.
- REMOVE 3" EXISTING SANITARY PIPING TO FLOOR DRAIN OF PENTHOUSE.
- REMOVE EXISTING PIPING DOWN TO FIRST FLOOR. REFER TO FIRST FLOOR PLUMBING DEMOLITION PLAN FOR CONTINUATION.
- REMOVE 4" EXISTING VENT PIPING UP TO PENTHOUSE. REFER
  TO PENTHOUSE PLUMBING DEMOLITION PLAN FOR
  CONTINUATION.
- REMOVE EXISTING CW LINE TO HUMIDIFIER IN PENTHOUSE. REFER TO PENTHOUSE PLUMBING DEMOLITION PLAN FOR CONTINUATION.


WARRANTY.

- 10. DEMOLISH EXISTING VENT THRU ROOF. PATCH ROOF COMPLETELY. ENSURE ROOF PATCHING WORK IS CONDUCTED IN A MANNER WHICH MAINTAINS ROOF MANUFACTURER'S
- 11. EXISTING VENT THRU ROOF TO REMAIN. REFER TO PLUMBING NEW WORK SECOND FLOOR PLAN, SHEET P3.2.

REVISIONS DATE COUNCIL OF STATE GOVERNMENTS - HEADQUARTERS BUILDING 2760 RESEARCH PARK DRIVE LEXINGTON, KY 40511 DRAWING NO PLUMBING DEMOLITION -**NOV. 2013** SECOND FLOOR PLAN COMMONWEALTH OF KENTUCKY
FINANCE AND ADMINISTRATION CABINET
DIVISION OF ENGINEERING & CONTRACT ADMINISTRATION
DEPARTMENT FOR FACILITIES AND SUPPORT SERVICES
FRANKFORT, KENTUCKY

P-2.2 DRAWN BY CHECKED BY CMR A & E FILE NO REVIEWED DIV. OF ENGR. 1302.00 212 North Upper Street Lexington, Kentucky 40507-1001 p 859.252.6664 f 859.253.2358 www.omnlarchitects.com CSG13 ENGR. FILE NO NOV. 2013 785-C6BR-BC01-00 AGENCY UTHORIZED AGENT\_ APPROVED FOR PROGRAM CONCEPT ONLY DIVISION OF ENGINEERING DATE \_\_\_\_\_\_ DATE \_\_\_\_\_\_ DATE \_\_\_\_\_\_


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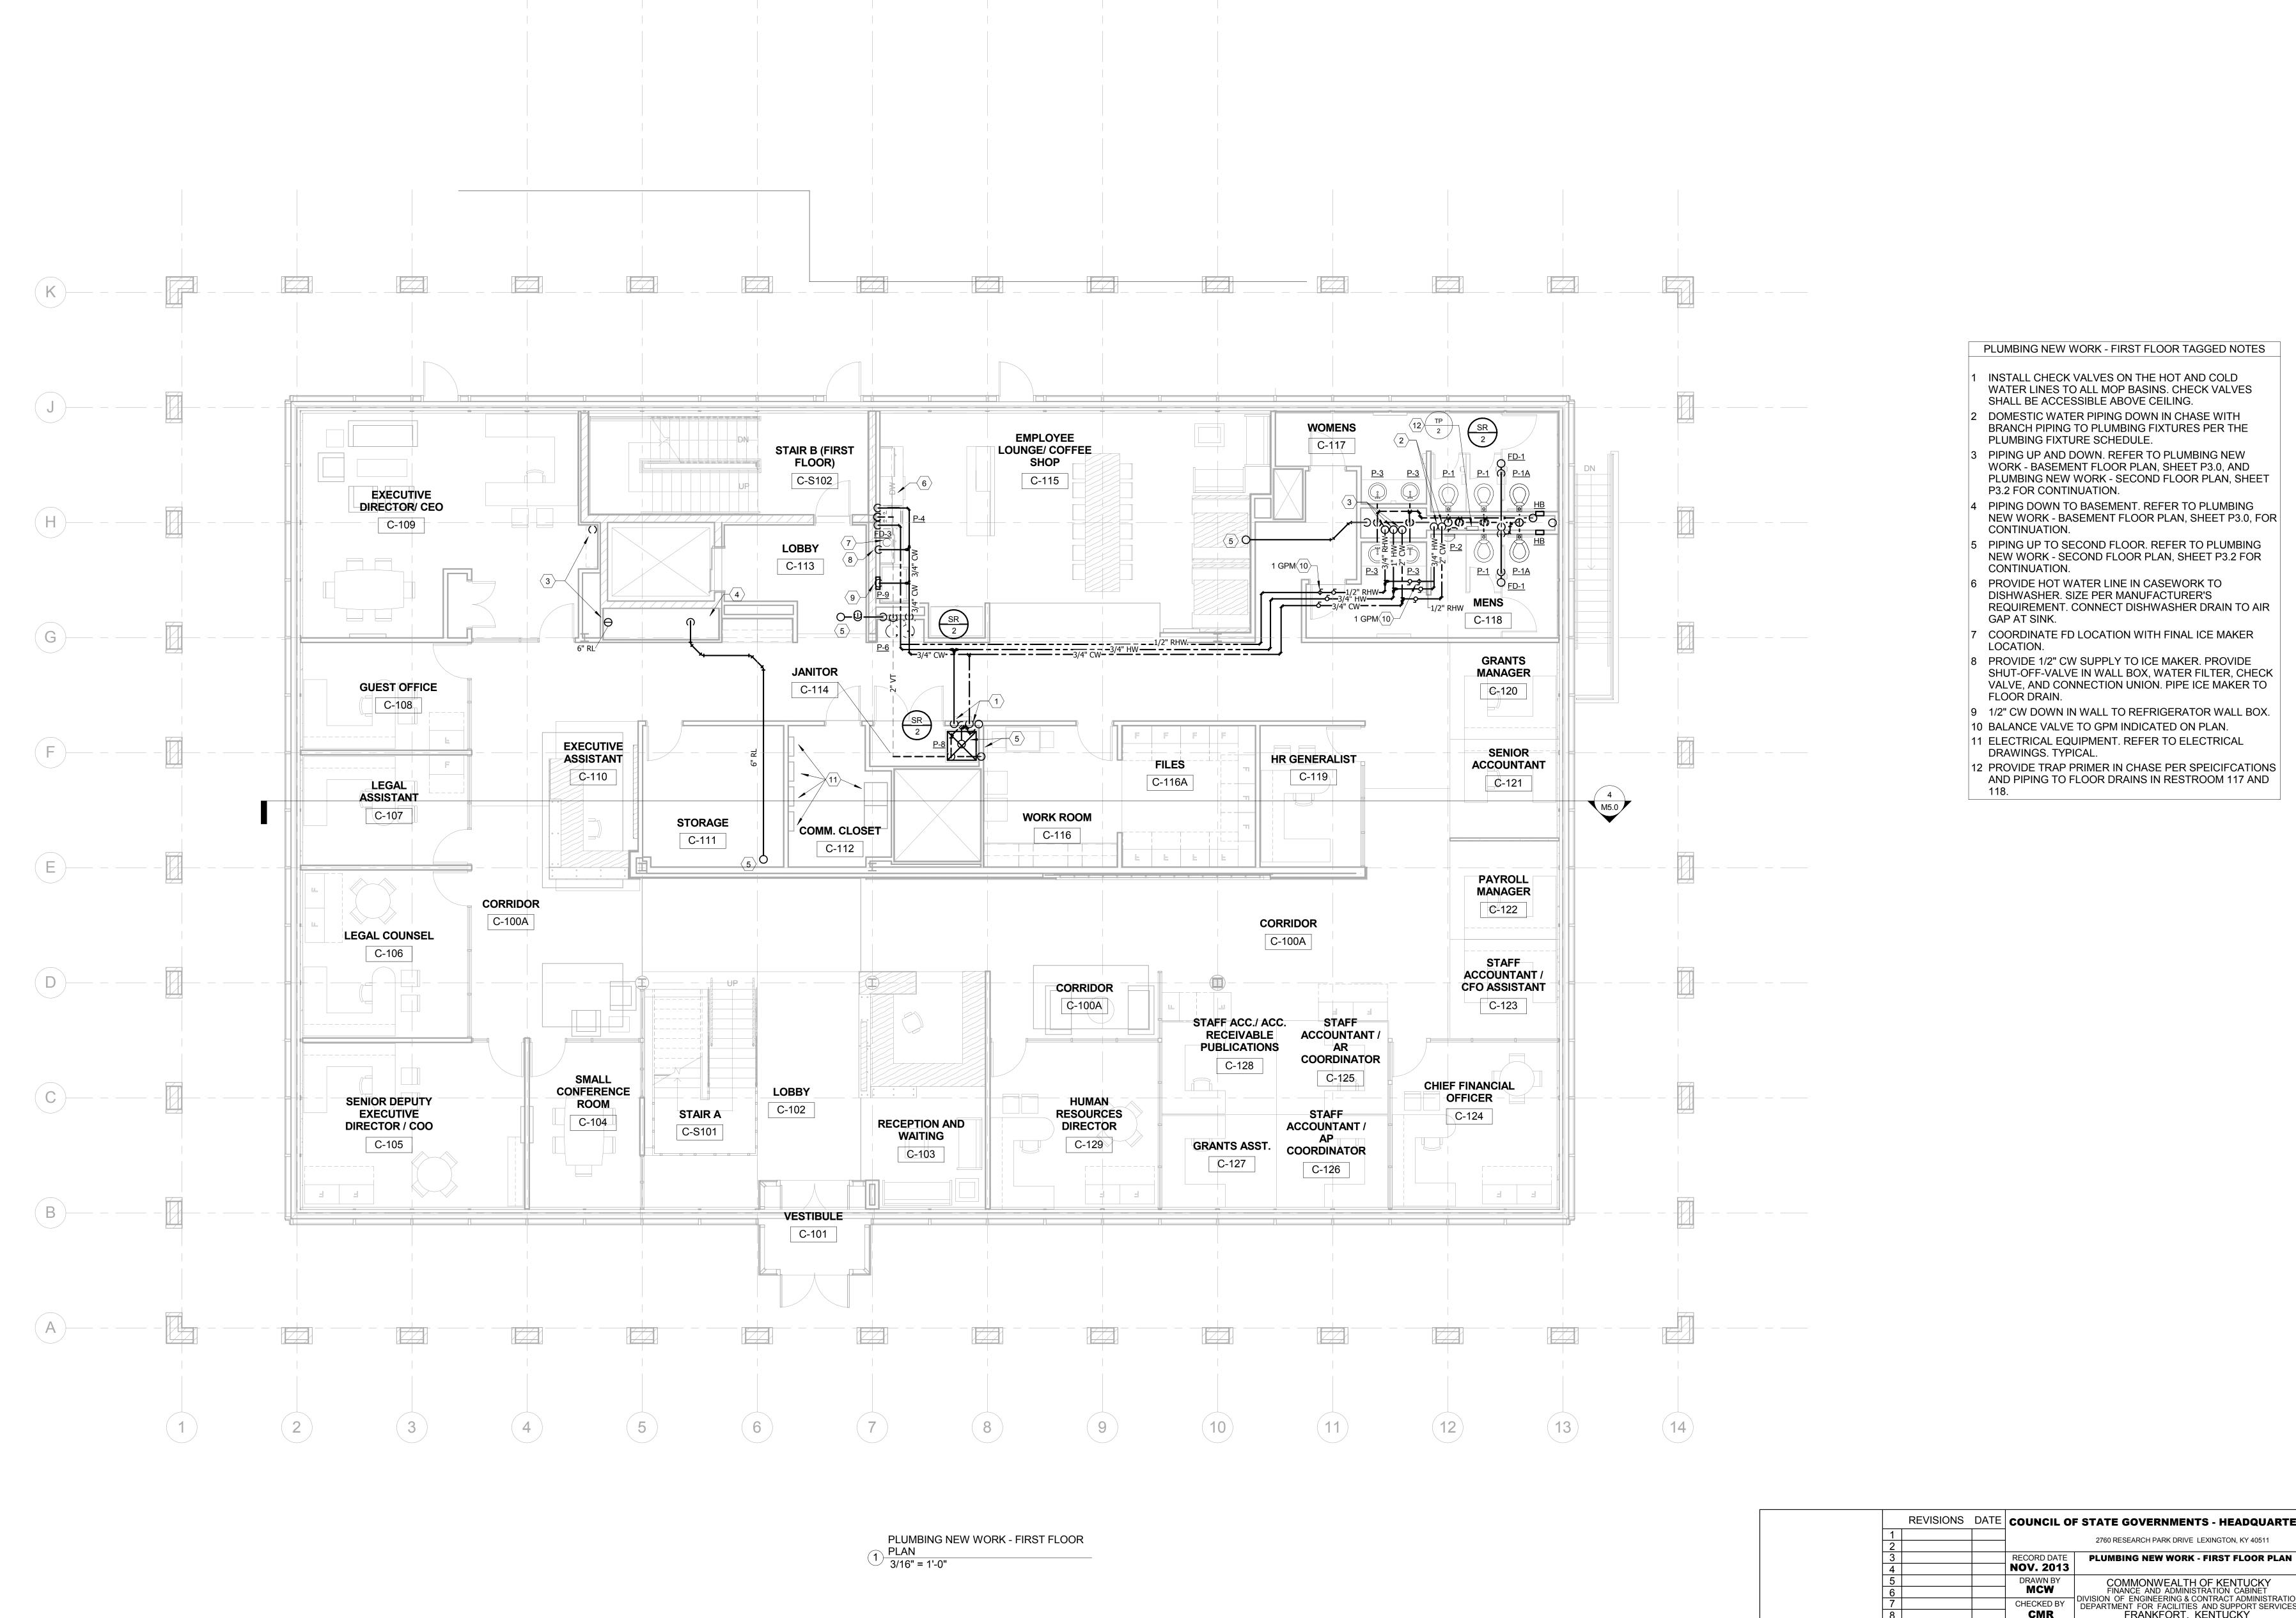


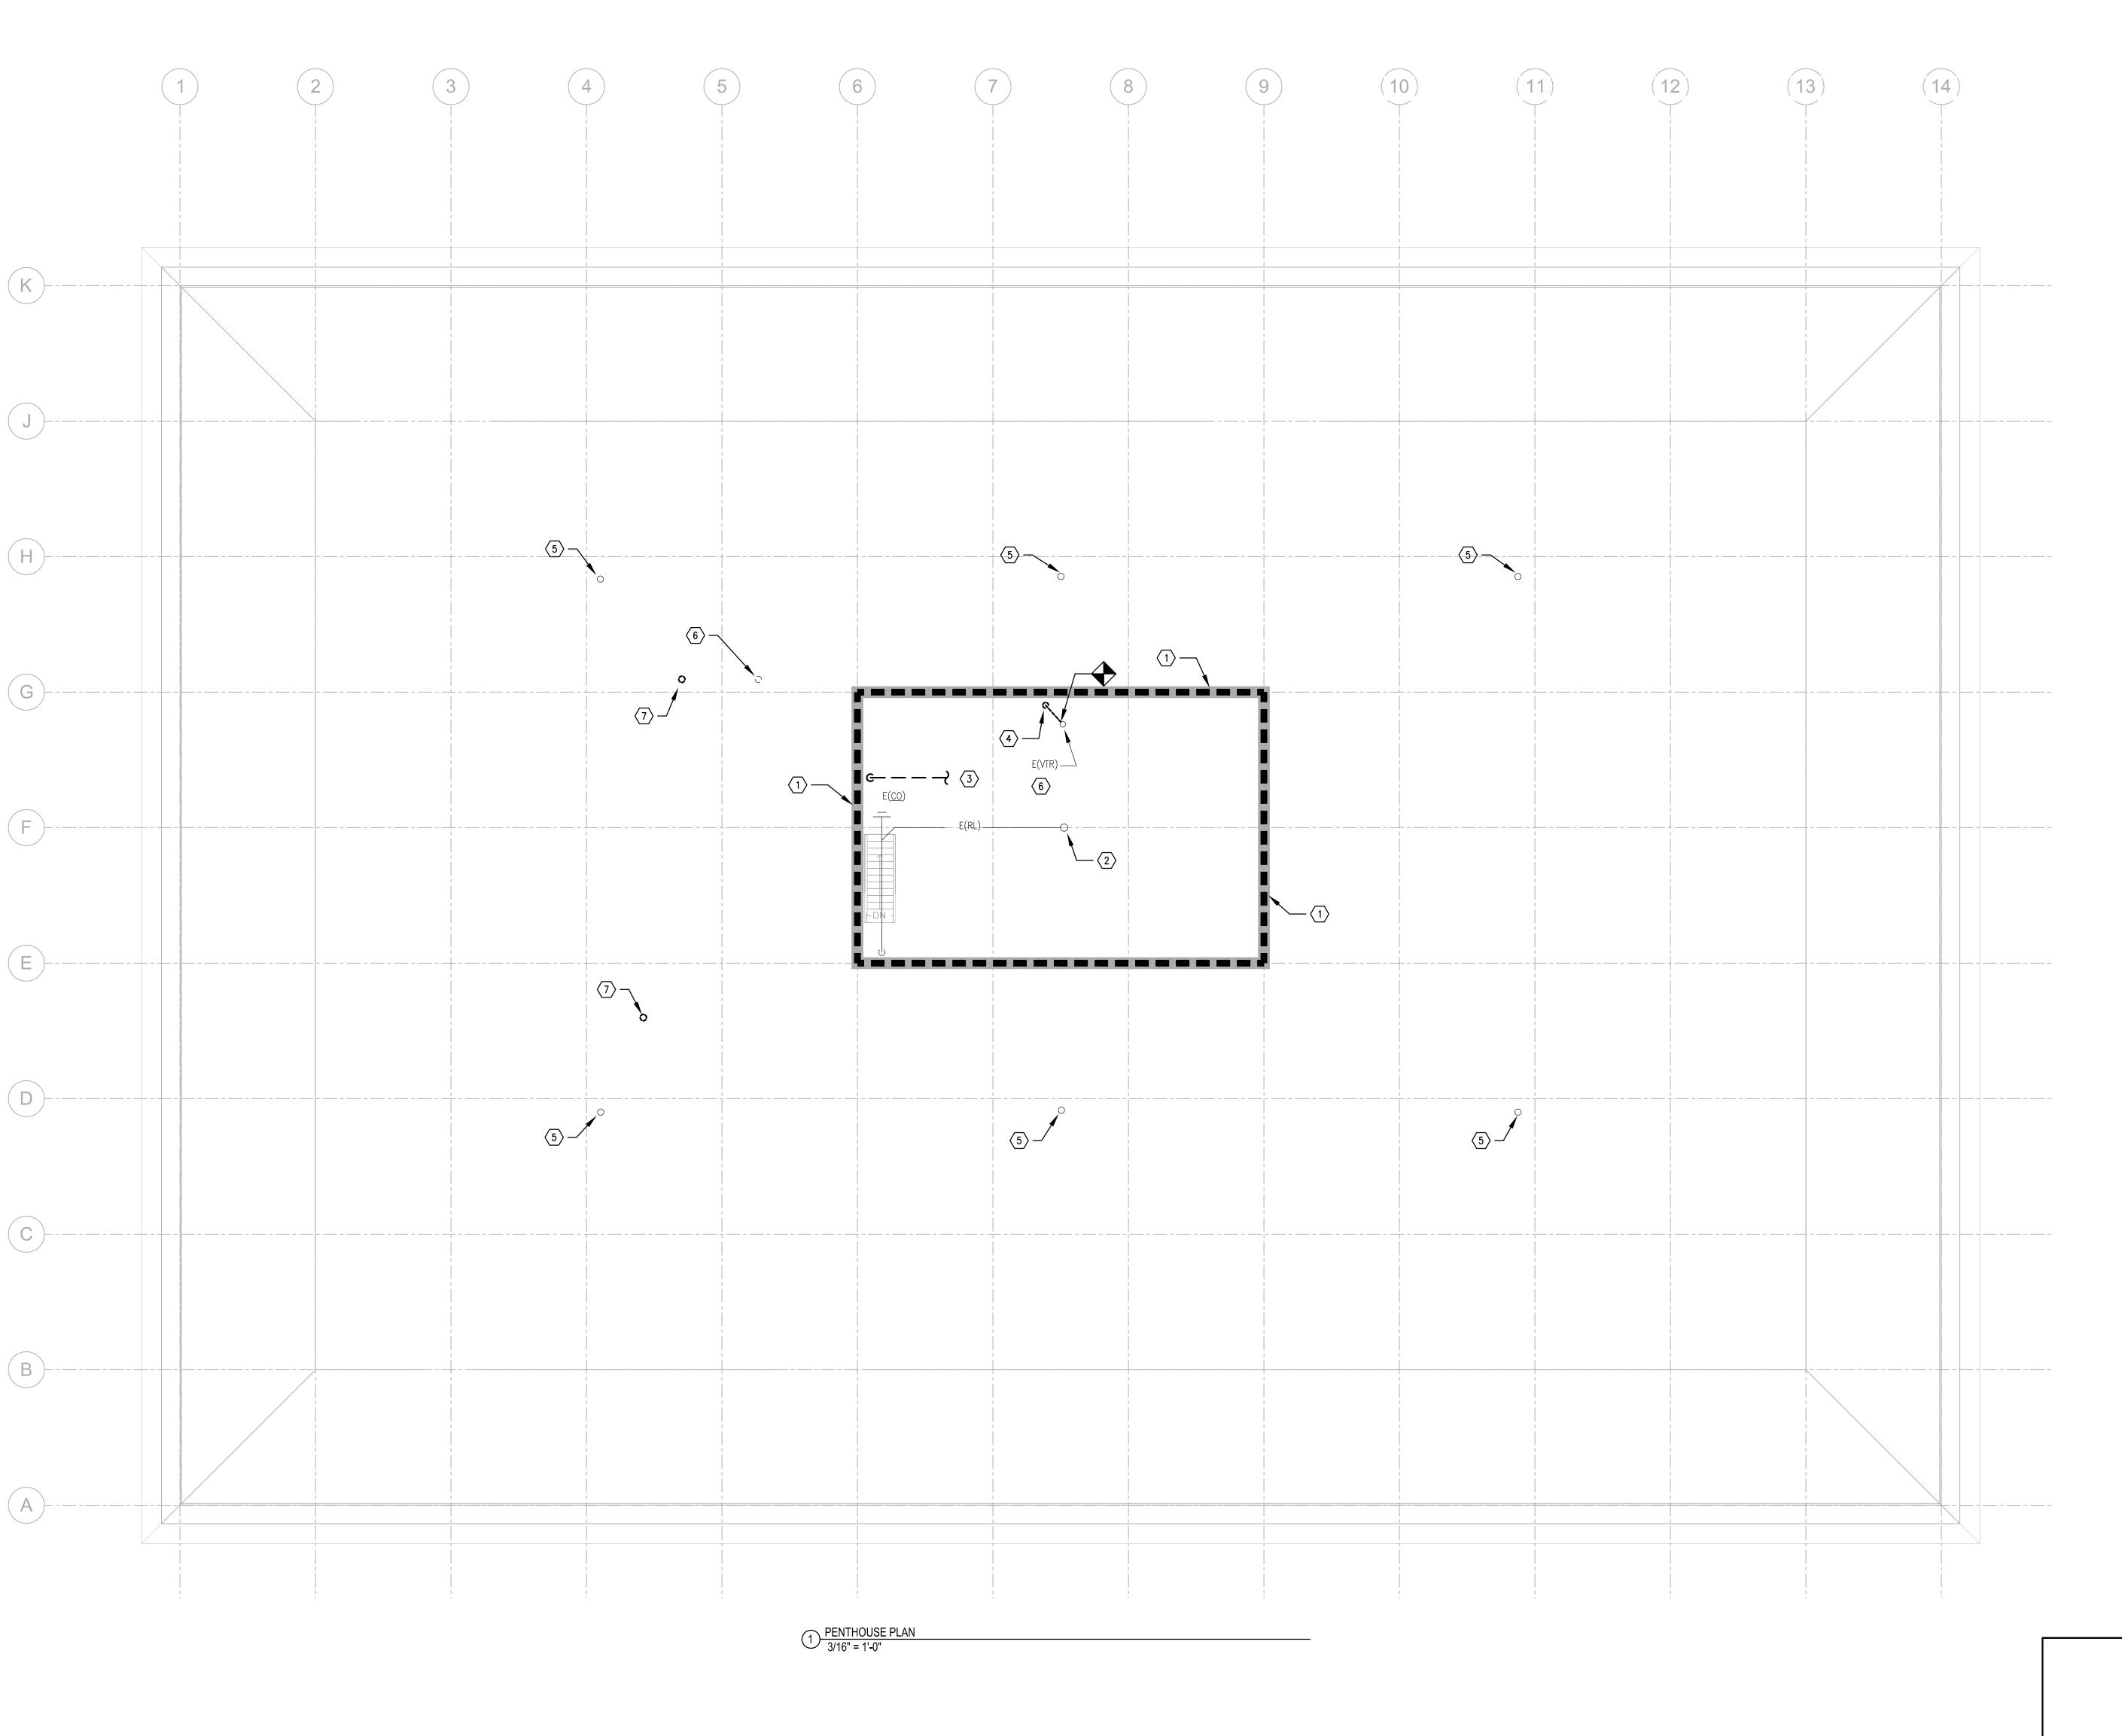TAGGED NOTES:

- REFER TO ARCHITECTURAL DRAWINGS FOR CEILING, WALL, AND FLOOR PATCH AND REPAIR REQUIREMENTS.
- 2. EXISTING ROOF LEADER PIPING UP TO ROOF DRAIN.
- 3. EXISTING CW FILL LINE TO HUMIDIFIER.
- EXISTING VENT PIPING DOWN TO 2ND FLOOR. REFER TO SECOND FLOOR PLUMBING DEMOLITION PLAN FOR CONTINUATION.
- 5. EXISTING ROOF DRAIN TO REMAIN.
- 6. EXISTING VENT THRU ROOF TO REMAIN.
- 7. DEMOLISH VENT THRU ROOF. PATCH ROOF COMPLETELY. ROOF PATCH WORK SHALL BE CONDUCTED IN A MANNER THAT MAINTAINS ROOF MANUFACTURER'S WARRANTY.
- 8. EXISTING MECHANICAL ROOF PENETRATION. REFER TO MECHANICAL DEMOLITION - PENTHOUSE PLAN, SHEET M2.3, FOR DETAILS.


REVISIONS DATE COUNCIL OF STATE GOVERNMENTS - HEADQUARTERS BUILDING 2760 RESEARCH PARK DRIVE LEXINGTON, KY 40511 PLUMBING DEMOLITION -DRAWING NO **NOV. 2013** PENTHOUSE PLAN COMMONWEALTH OF KENTUCKY
FINANCE AND ADMINISTRATION CABINET
DIVISION OF ENGINEERING & CONTRACT ADMINISTRATION
DEPARTMENT FOR FACILITIES AND SUPPORT SERVICES
FRANKFORT, KENTUCKY DRAWN BY CHECKED BY A & E FILE NO REVIEWED DIV. OF ENGR. 1302.00 212 North Upper Street Lexington, Kentucky 40507-1001 p 859.252.6664 f 859.253.2358 www.omnlarchltects.com CSG13 ENGR. FILE NO NOV. 2013 785-C6BR-BC01-00 UTHORIZED AGENT\_ APPROVED FOR PROGRAM CONCEPT ONLY DIVISION OF ENGINEERING \_\_\_\_\_ DATE \_\_\_\_\_ DATE \_\_\_\_\_



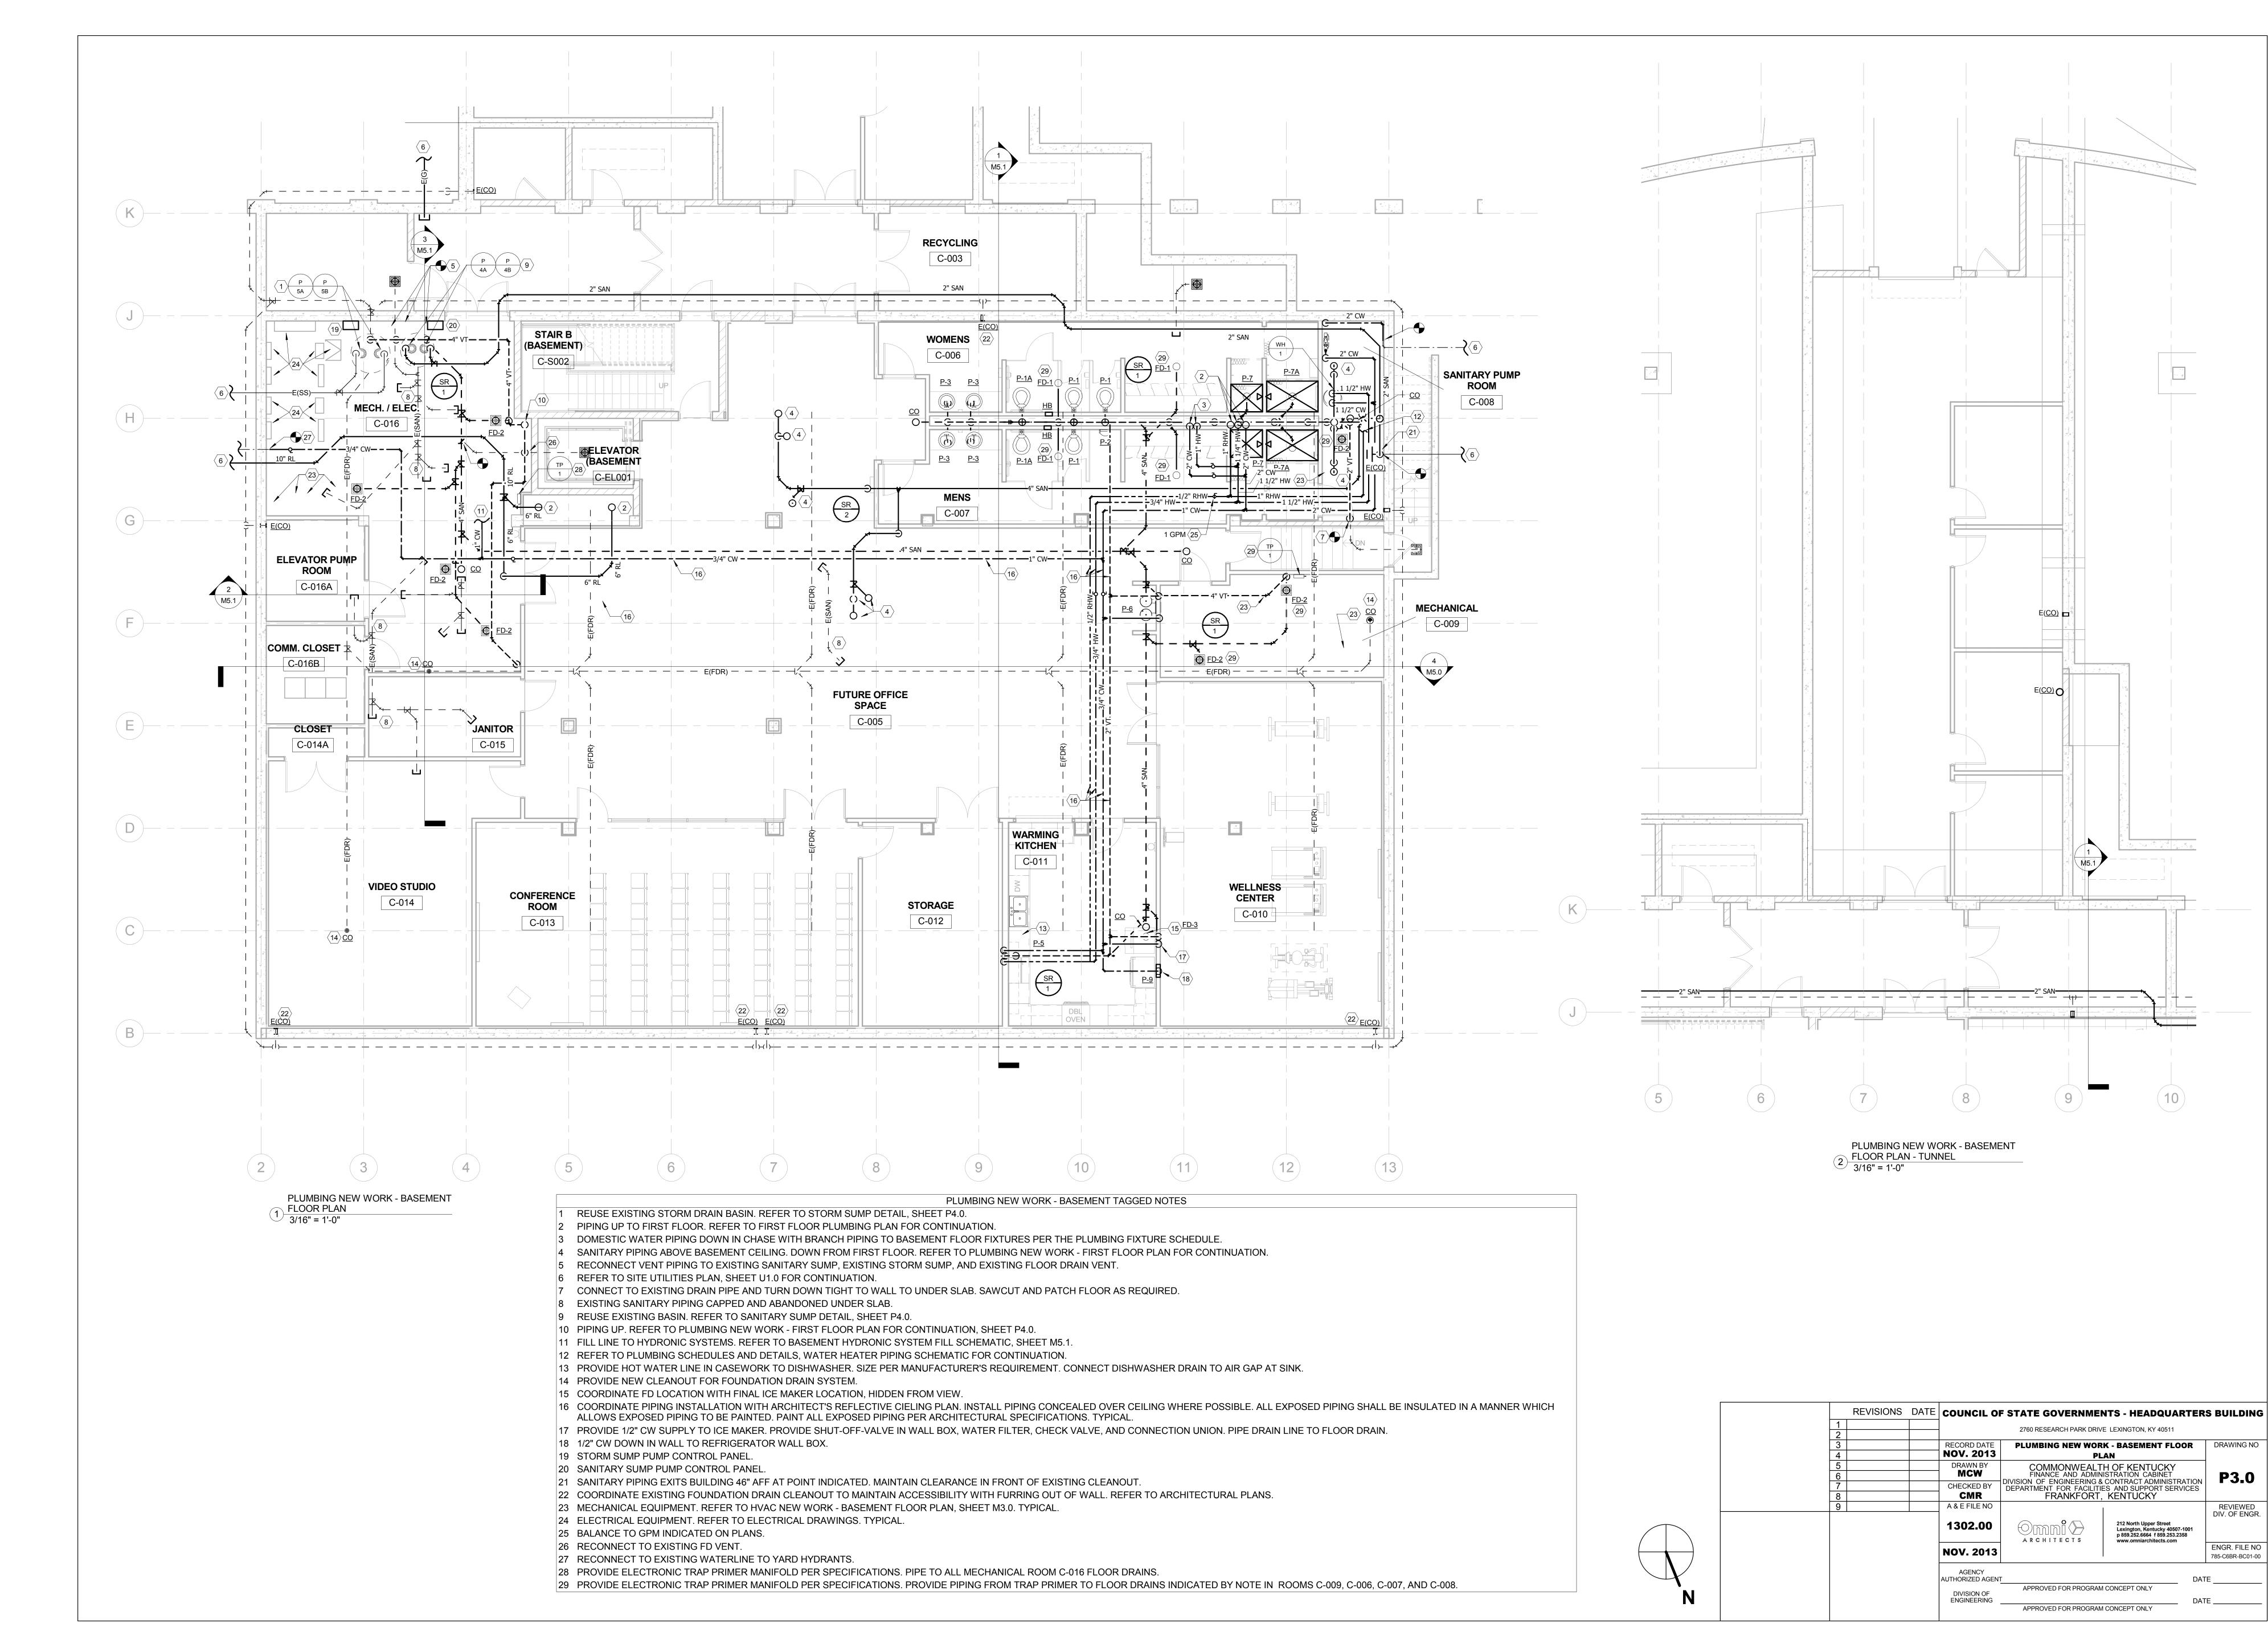

REVISIONS DATE COUNCIL OF STATE GOVERNMENTS - HEADQUARTERS BUILDING PLUMBING NEW WORK - FIRST FLOOR PLAN DRAWING NO COMMONWEALTH OF KENTUCKY
FINANCE AND ADMINISTRATION CABINET
VISION OF ENGINEERING & CONTRACT ADMINISTRATION

P3.1 DEPARTMENT FOR FACILITIES AND SUPPORT SERVICES
FRANKFORT, KENTUCKY CMR A & E FILE NO REVIEWED DIV. OF ENGR. ⊕mnî 🏖 212 North Upper Street Lexington, Kentucky 40507-1001 p 859.252.6664 f 859.253.2358 1302.00 ARCHITECTS ENGR. FILE NO NOV. 2013 785-C6BR-BC01-00 AUTHORIZED AGENT APPROVED FOR PROGRAM CONCEPT ONLY DIVISION OF ENGINEERING DATE \_\_\_\_\_\_ DATE \_\_\_\_\_

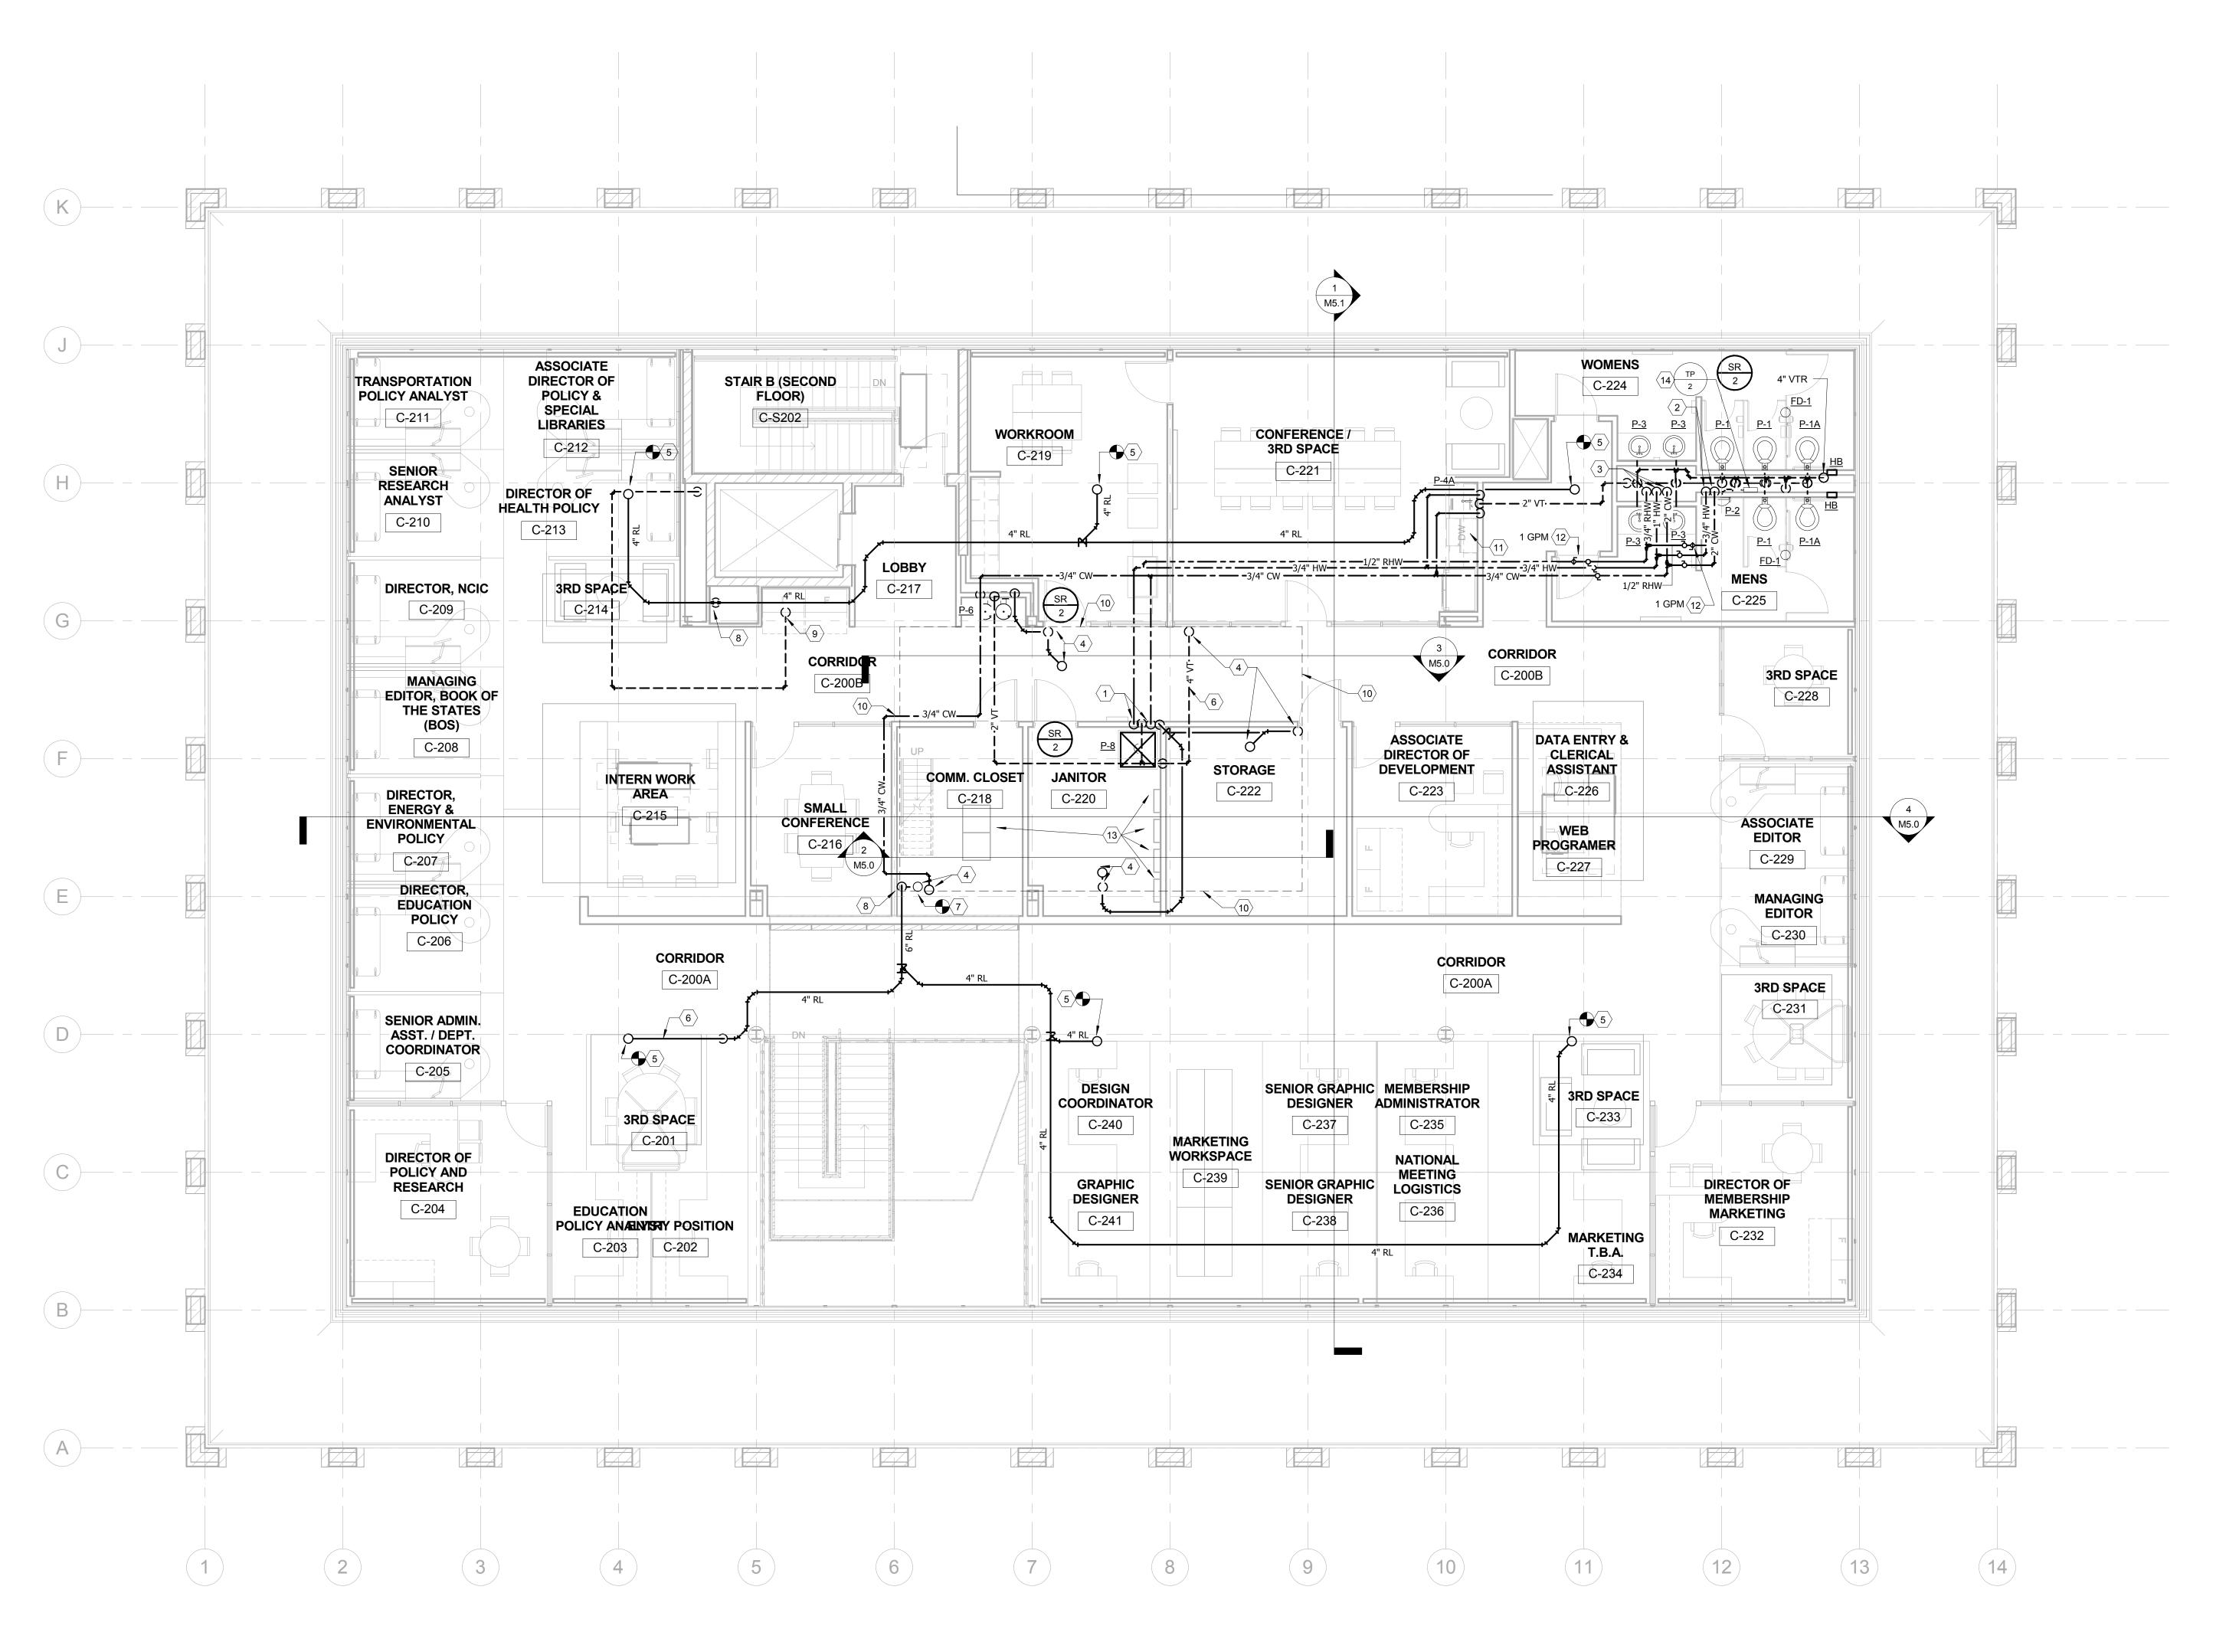

PLUMBING NEW WORK - SECOND FLOOR
PLAN
3/16" = 1'-0"

REVISIONS DATE COUNCIL OF STATE GOVERNMENTS - HEADQUARTERS BUILDING 2760 RESEARCH PARK DRIVE LEXINGTON, KY 40511 PLUMBING NEW WORK - SECOND FLOOR DRAWING NO RECORD DATE **NOV. 2013** COMMONWEALTH OF KENTUCKY FINANCE AND ADMINISTRATION CABINET MCW FINANCE AND ADMINISTRATION CABINET
ISSION OF ENGINEERING & CONTRACT ADMINISTRATION

P3.2 CHECKED BY DEPARTMENT FOR FACILITIES AND SUPPORT SERVICES **CMR** FRANKFORT, KENTUCKY A & E FILE NO REVIEWED DIV. OF ENGR. 212 North Upper Street Lexington, Kentucky 40507-1001 p 859.252.6664 f 859.253.2358 1302.00 ARCHITECTS ENGR. FILE NO **NOV. 2013** 785-C6BR-BC01-00 AUTHORIZED AGENT APPROVED FOR PROGRAM CONCEPT ONLY DIVISION OF ENGINEERING \_\_\_\_\_\_\_APPROVED FOR PROGRAM CONCEPT ONLY

INSTALL CHECK VALVES ON THE HOT AND COLD WATER LINES TO ALL MOP BASINS.
 DOMESTIC WATER PIPING DOWN IN CHASE WITH

PLUMBING NEW WORK - SECOND FLOOR TAGGED NOTES

BRANCH PIPING TO FIXTURES PER THE PLUMBING FIXTURE SCHEDULE.

3 DOMESTIC WATER PIPING DOWN TO FIRST FLOOR.

REFER TO PLUMBING NEW WORK - FIRST FLOOR PLAN FOR CONTINUATION.

4 PIPING UP TO PENTHOUSE. REFER TO PLUMBING NEW

4 PIPING UP TO PENTHOUSE. REFER TO PLUMBING NEW WORK - PENTHOUSE PLAN, SHEET M3.3, FOR CONTINUATION.

5 ROOF LEADER PIPING UP TO ROOF DRAIN. CONNECT TO EXISTING DRAIN.

ROUTE PIPING UP IN JOIST SPACE.

7 RECONNECT TO 3" EXISTING ROOF LEADER PIPING DOWN FROM PENTHOUSE. REFER TO PLUMBING NEW WORK - PENTHOUSE PLAN, SHEET M3.3 FOR CONTINUATION.

8 6" ROOF LEADER PIPING DOWN. REFER TO PLUMBING NEW WORK - 1ST FLOOR PLAN, SHEET M3.1, FOR CONTINUATION.

9 RECONNECT TO EXISTING VENT THRU ROOF.


10 MECHANICAL PENTHOUSE ABOVE.

11 PROVIDE HOT WATER LINE IN CASEWORK TO DISHWASHER. SIZE PER MANUFACTURER'S RECOMMENDATIONS. CONNECT DISHWASHER DRAIN TO AIR GAP AT SINK.

12 BALANCE VALVE TO GPM INDICATED ON PLANS.13 ELECTRICAL EQUIPMENT. REFER TO ELECTRICAL

B ELECTRICAL EQUIPMENT. REFER TO DRAWINGS. TYPICAL.

14 PROVIDE TRAP PRIMER IN CHASE PER SPECIFICATIONS AND PIPING TO FLOOR DRAINS IN RESTROOM 224 AND

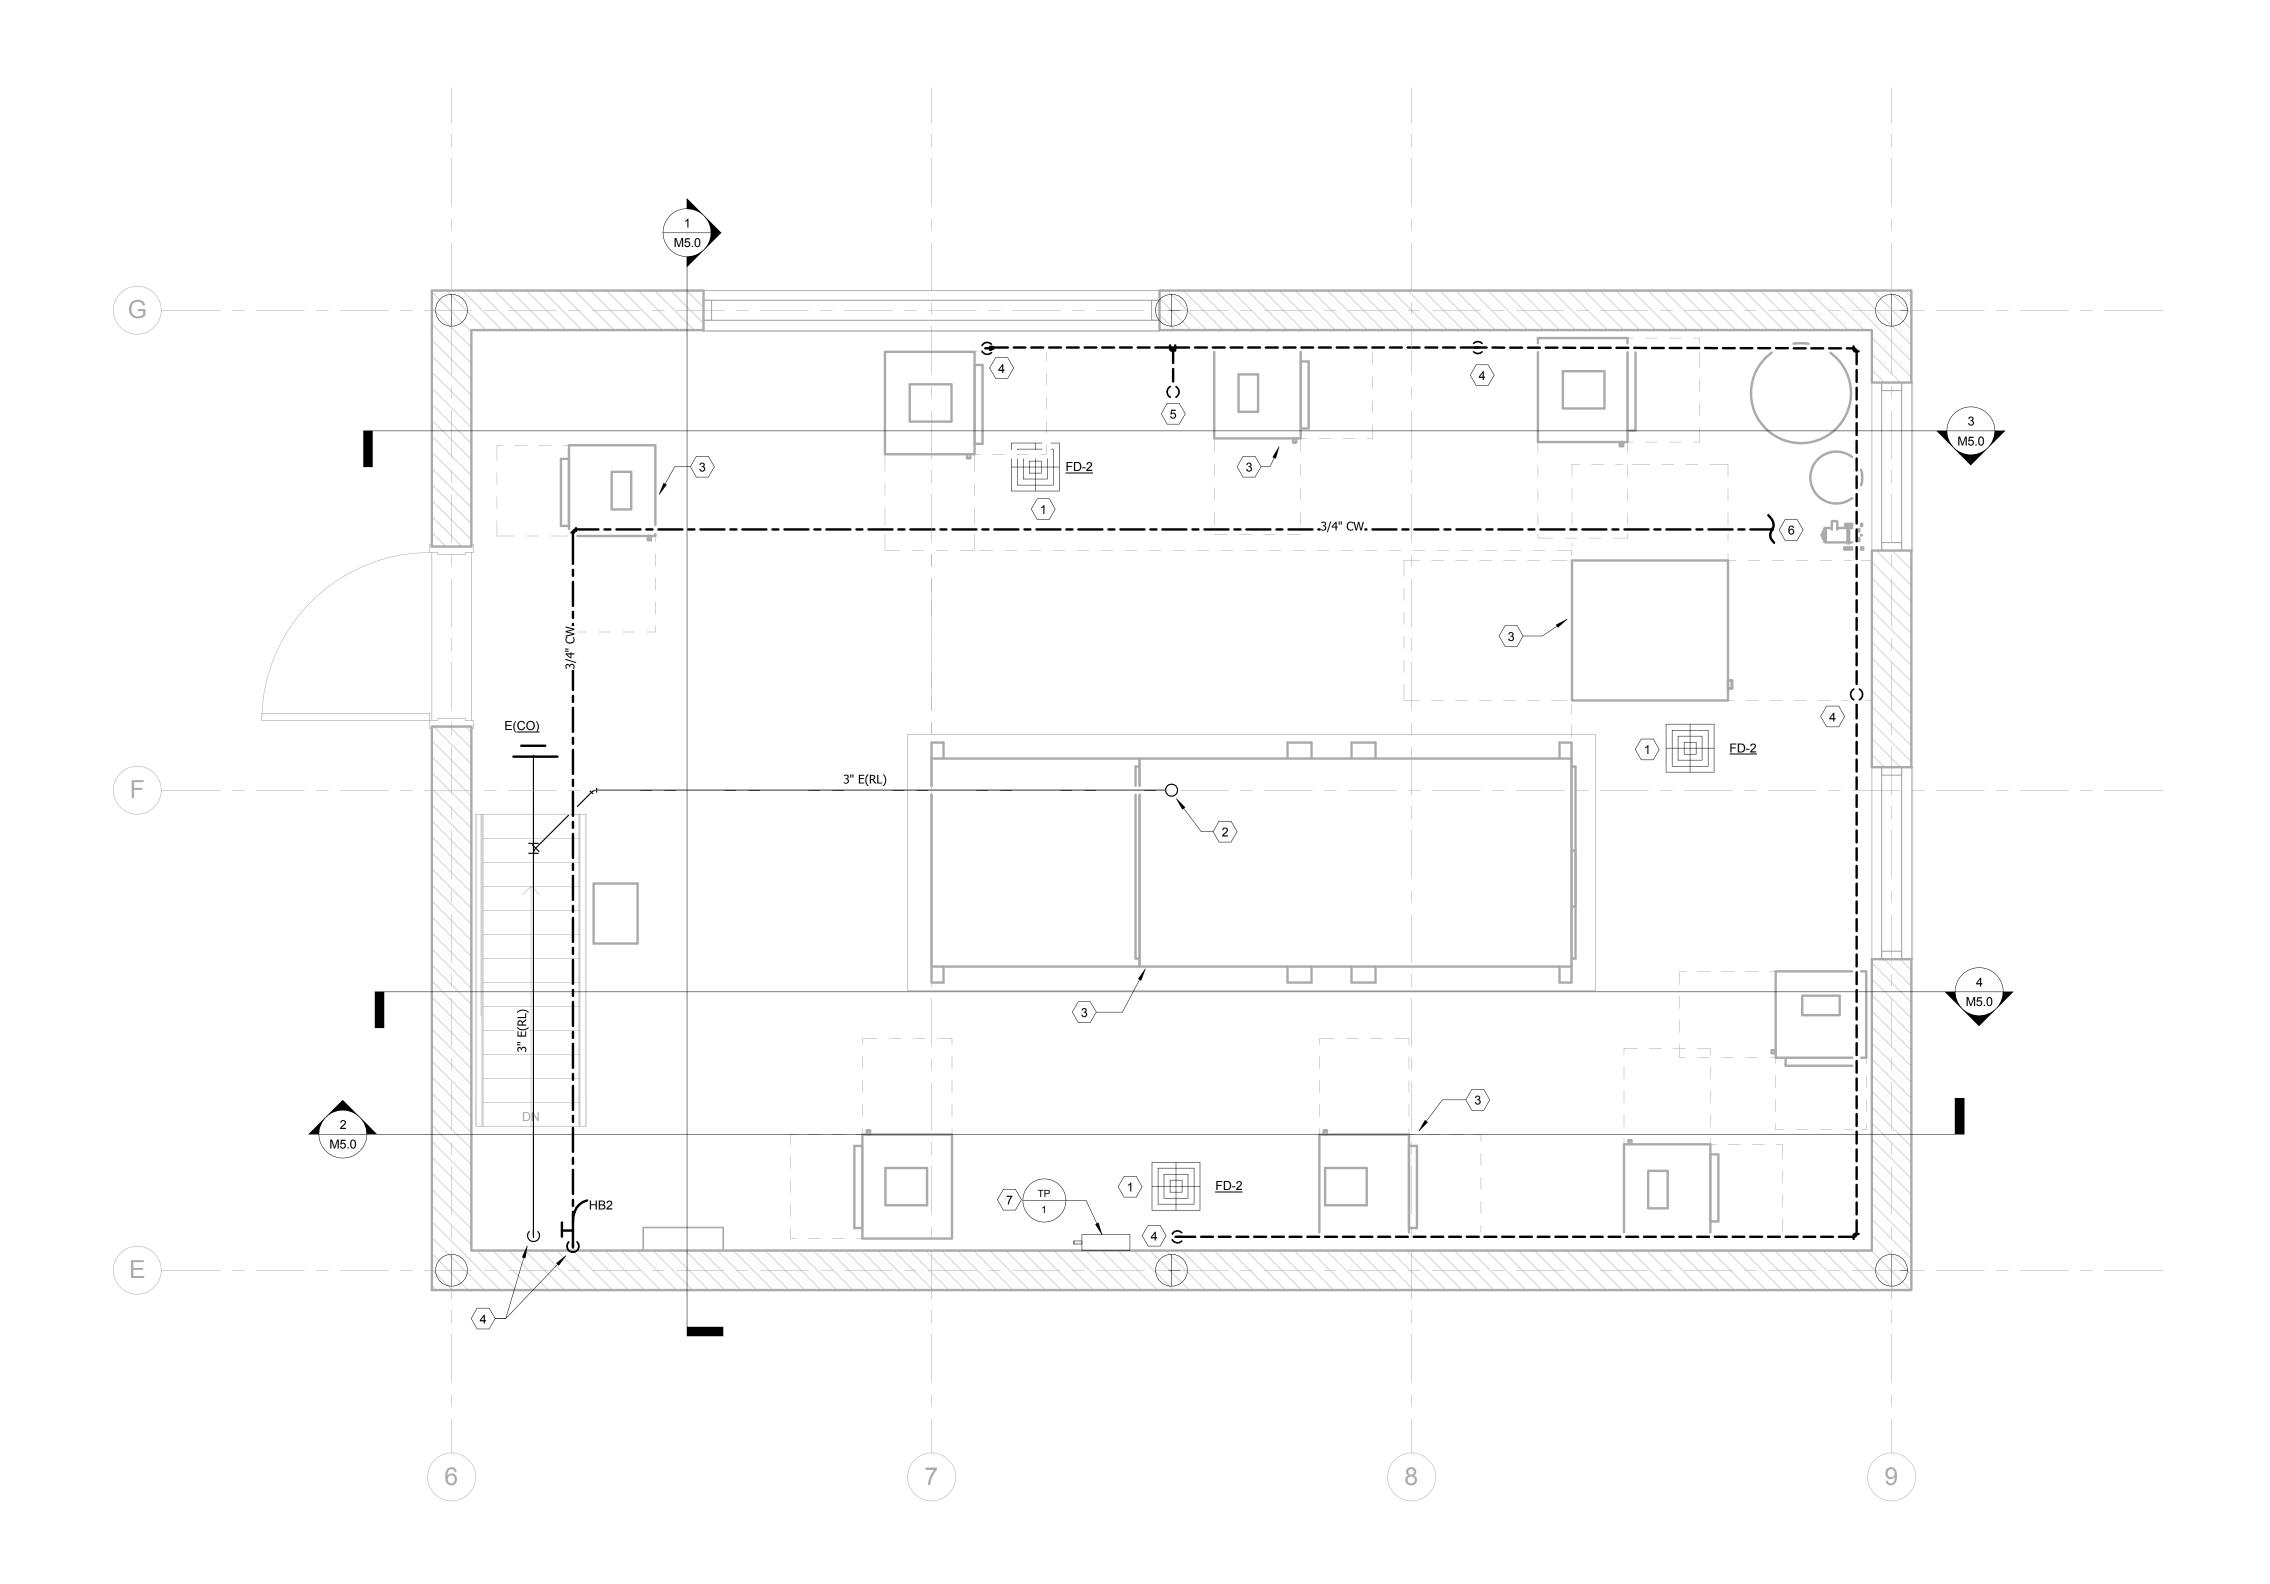


PLUMBING NEW WORK - PENTHOUSE
PLAN
1/2" = 1'-0"

#### PLUMBING NEW WORK - PENTHOUSE TAGGED NOTES

- 1 COORDINATE FLOOR DRAIN LOCATION WITH DUCTWORK PENETRATIONS.
- 2 EXISTING ROOF LEADER PIPING UP TO ROOF DRAIN ABOVE.
   3 MECHANICAL EQUIPMENT. REFER TO HVAC NEW WORK -
- PENTHOUSE PLAN, SHEET M3.3. TYPICAL.

  4 PIPING DOWN THRU PENTHOUSE FLOOR. REFER TO PLUMBING NEW WORK SECOND FLOOR PLAN, SHEET P3.2,
- FOR CONTINUATION.

  RECONNECT VENT PIPING TO EXISTING VENT THRU ROOF.
- FILL LINE FOR HCW SYSTEM. REFER TO PENTHOUSE HYDRONIC SYSTEM FILL SCHEMATIC, SHEET M5.1 FOR DETAILS.
- 7 PROVIDE ELECTRIC TRP PRIMER PER SPECIFICATIONS. PROVIDE PIPING TO ALL PENTHOUSE FLOOR DRAINS.

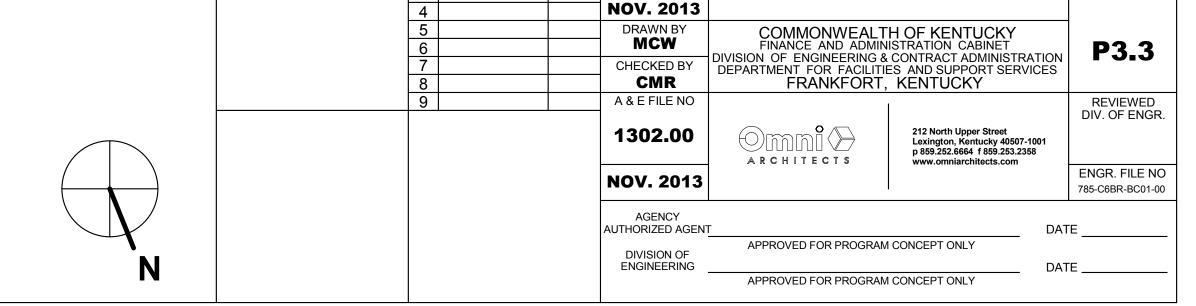



RECORD DATE

REVISIONS DATE COUNCIL OF STATE GOVERNMENTS - HEADQUARTERS BUILDING

2760 RESEARCH PARK DRIVE LEXINGTON, KY 40511


PLUMBING NEW WORK - PENTHOUSE PLAN DRAWING NO

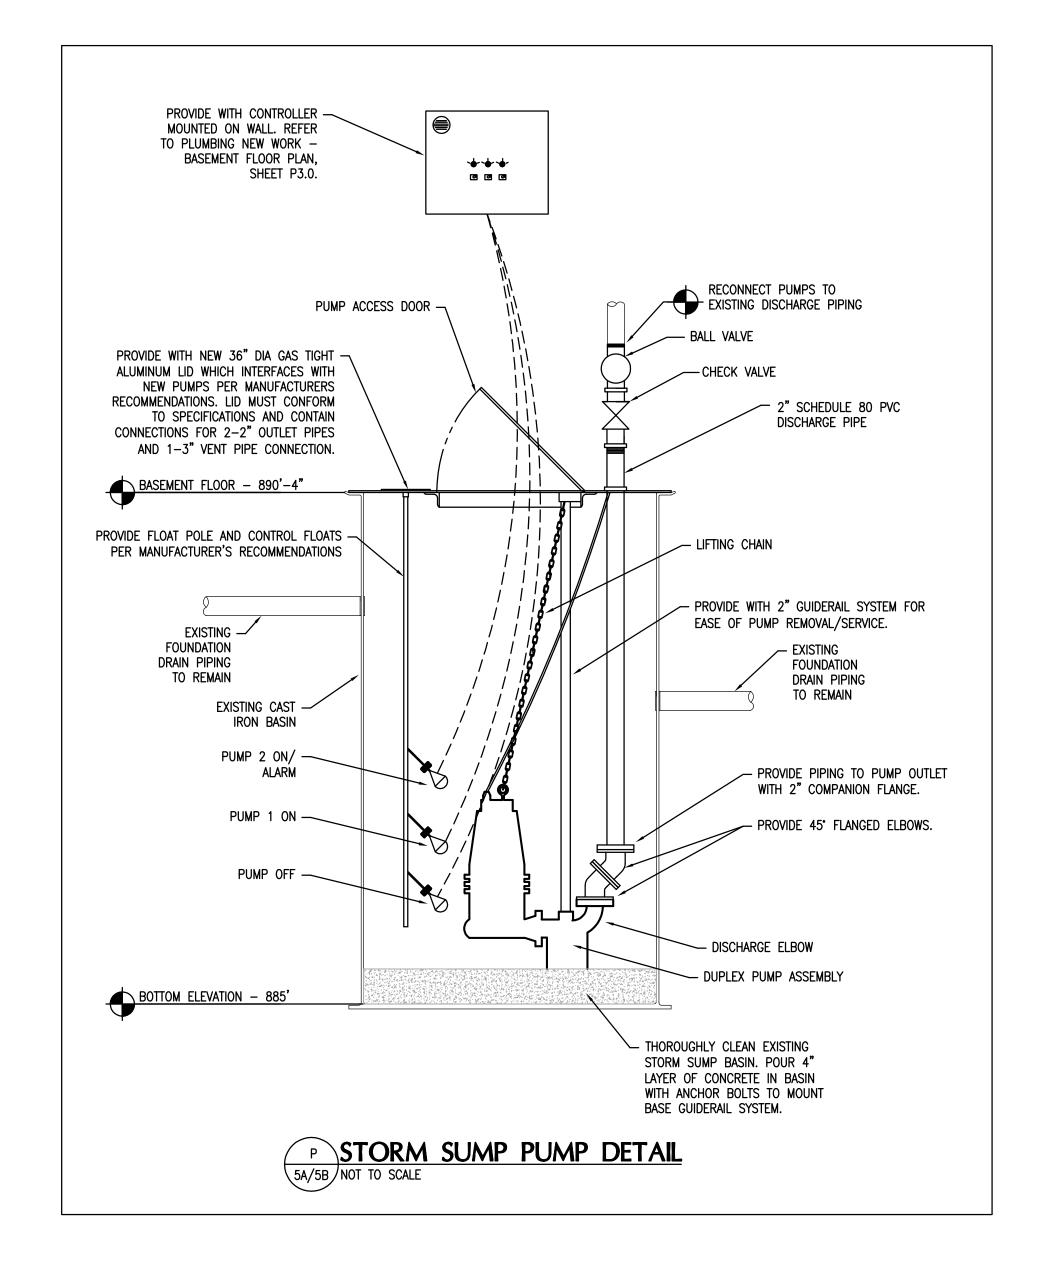


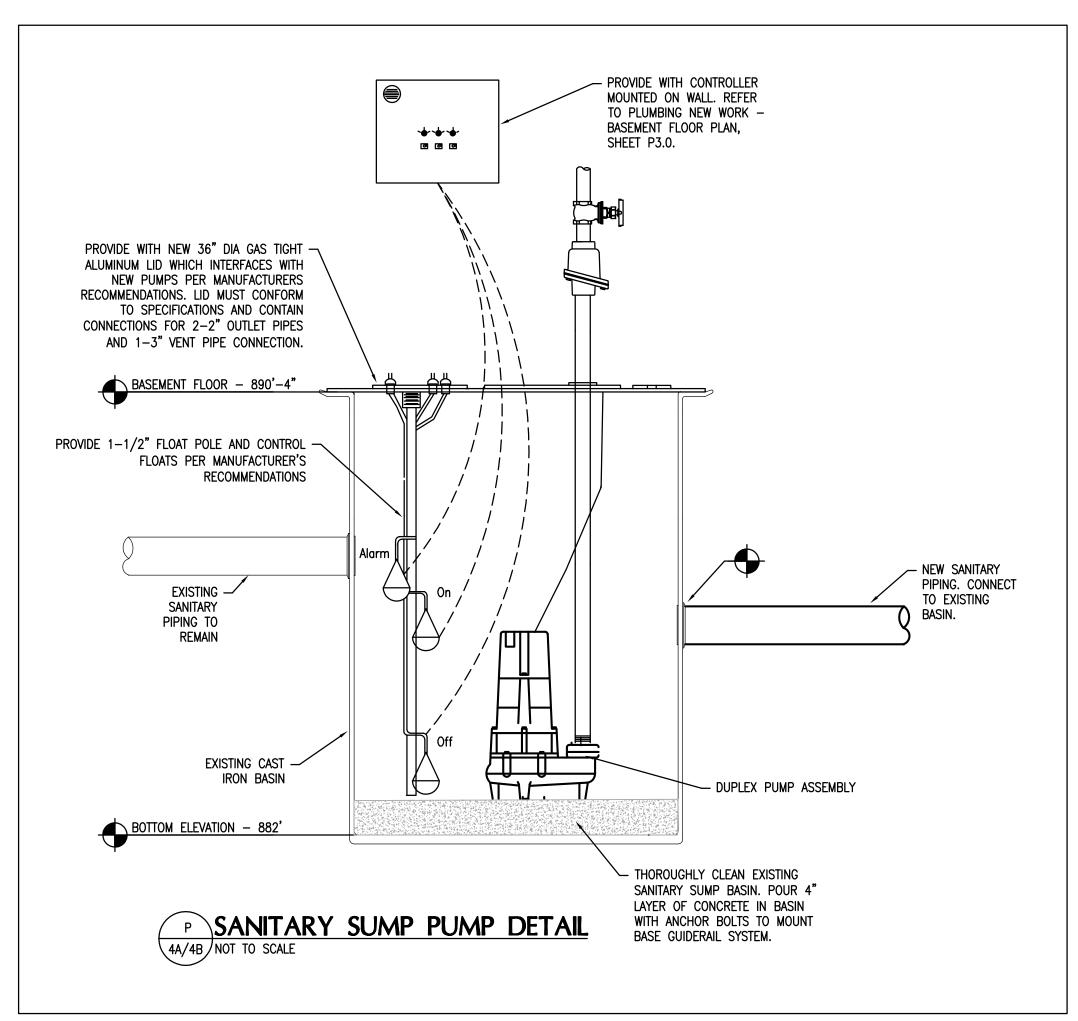

WATER HEATER SCHEDULE (AS-BUILT)									
	MARK	MANUFACTURER MODEL	SERVICE	STORAGE (GAL)	RECOVERY GPH • 100°F RISE	KW	ELECTRICAL (VOLT/PH)	REMARKS	
	WH-1								

	PLUMBING PUMP SCHEDULE (AS-BUILT)											
MARK	MANUFACTURER MODEL	SERVICE	HP	HEAD LOSS (FT)	GPM	ELECTRICAL (VOLT/ø)	REMARKS					
RP-1		BUILDING RECIRC.										
P-4A/B		SEWER SUMP PUMP										
P-5A/B		STORM SUMP PUMP										

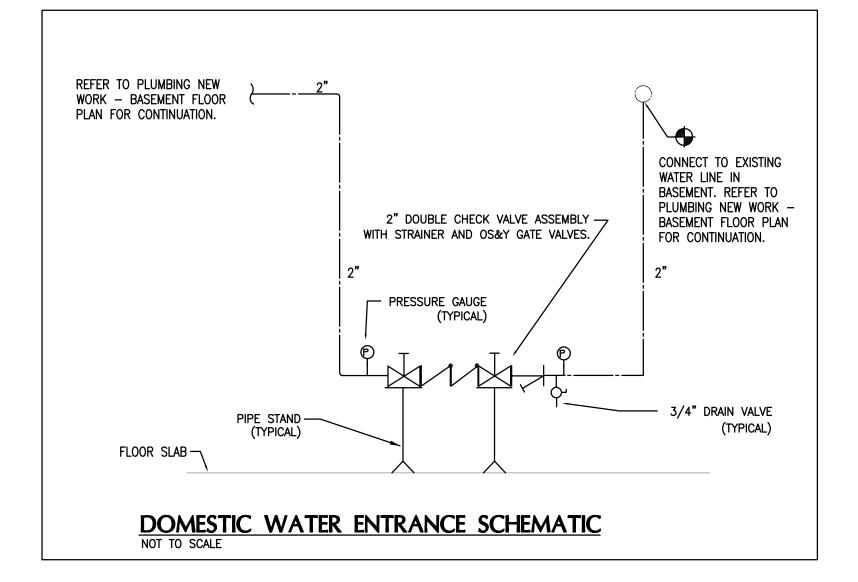

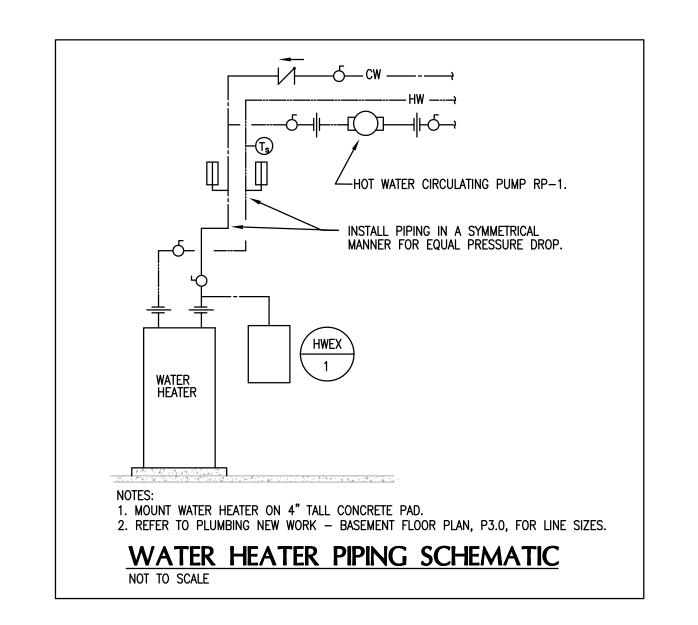

		PLUMBINC	3 PUN	MP SC	HEDULE			
MARK	MANUFACTURER MODEL	SERVICE	HP	GPM	HEAD LOSS (FT)	FLA	ELECTRICAL (VOLT/ø)	REMARKS
RP-1	BELL & GOSSETT PL-30B	BUILDING RECIRC.	1/12	5	6.3	1.4	115/1	1, 2, 3
P-4A/B	ZOELLER 7011	SEWER SUMP PUMP	1.5	40	13.55	12.3	115/1	4, 5
P-5A/B	ZOELLER 6188	STORM SUMP PUMP	1.5	106	13.55	10.3	208/3	4, 5

1. PUMP IS CONTROLLED BY BUILDING AUTOMATION SYSTEM.
2. EQUALS INCLUDES GRUNDFOS, ARMSTRONG AND THRUSH.
3. BRONZE CONSTRUCTION AND LEAD FREE, FOR DOMESTIC WATER USE.

4. PROVIDE WITH FACTORY CONTROLLER AND ALL REQUIRED FLOAT SENSORS, PUMP GUIDE RAILS, ETC. SEE DETAIL, THIS SHEET. 5. EQUALS INCLUDE WEIL AND CRANE.

	PLUMBING FIXTURE SCHEDULE						
	NOTES; FER TO MECHANICAL SPECIFICATIONS FOR ACCEPTABLE MANUFACTURERS. E SIZE TYPICAL, UNLESS NOTED OTHERWISE ON RISERS OR PLANS.						
MARK	DESCRIPTION	HW	CW	WASTE	VENT	GPF	GPM
<u>P-1</u>	WATER CLOSET — WALL HUNG — BATTERY SENSOR FLUSH VALVE  VITREOUS CHINA, WALL HUNG ELONGATED BOWL, SIPHON JET, 1½" TOP SPUD INLET, CHINA BOLT CAPS AND WHITE OPEN FRONT PLASTIC SEAT WITH SELF—SUSTAINING CHECK HINGES. PROVIDE WITH A BATTERY POWERED, SIDE MOUNT SENSOR OPERATED 1.28 GPF FLUSH VALVE WITH OVERRIDE BUTTON AND CHROME PLATED HOUSING. PROVIDE WALL CARRIER. MOUNT WITH RIM OF BOWL AT 15" AFF. SIMILAR TO TOTO MODEL CT708E.	-	1½"	4"	2"	1.28	-
<u>P-1A</u>	WATER CLOSET — WALL HUNG — BATTERY SENSOR FLUSH VALVE — ADA COMPLIANT  VITREOUS CHINA, WALL HUNG ELONGATED BOWL, SIPHON JET, 1½" TOP SPUD INLET, CHINA BOLT CAPS AND WHITE OPEN FRONT PLASTIC SEAT WITH SELF—SUSTAINING CHECK HINGES. PROVIDE WITH A BATTERY POWERED, SIDE MOUNT SENSOR OPERATED 1.28 GPF FLUSH VALVE WITH OVERRIDE BUTTON AND CHROME PLATED HOUSING. PROVIDE WALL CARRIER. MOUNTED WITH RIM OF BOWL AT 18" AFF. FLUSH VALVE HANDLE SHALL BE A MAXIMUM OF 31" AFF. SIMILAR TO TOTO MODEL CT708E.	-	1½"	4"	2"	1.28	-
<u>P-2</u>	URINAL — BATTERY POWERED SENSOR FLUSH VALVE — ADA COMPLIANT  VITREOUS CHINA SIPHON JET URINAL WITH ¾" TOP SPUD INLET AND 2" I.P.S. OUTLET. PROVIDE WITH BATTERY POWERED, SIDE MOUNT SENSOR OPERATED 1.0 GPF FLUSH VALVE WITH OVERRIDE BUTTON AND CHROME PLATED HOUSING. PROVIDE WITH FLOOR MOUNTED WALL CARRIER. MOUNT WITH LIP AT 16" AFF.	-	3/4"	2"	2"	0.125	-
<u>P-3</u>	LAVATORY — UNDERCOUNTER — ADA COMPLIANT  VITREOUS CHINA, 19"X15" OVAL UNDERCOUNTER LAVATORY WITH FRONT OVERFLOW. PROVIDE WITH A .5 GPM SINGLE LEVER FAUCET, GRID DRAIN, ¾" ANGLE SUPPLIES WITH STOPS, KENTUCKY CODE P—TRAP, TAILPIECE AND ESCUTCHEONS. INSTALL ON THE SUPPLY LINES AND P—TRAP AN INSULATION KIT WITH A VINYL PLASTIC COVERING. SIMILAR TO TOTO MODEL LT587. COLOR TO BE SELECTED BY ARCHITECT.	½"	<i>½</i> "	2"	2"	-	0.5
<u>P-4</u>	SINGLE COMPARTMENT SINK  SINGLE COMPARTMENT STAINLESS STEEL SINK, 19"X21" O.D., 14"X18" I.D., 6½" DEEP, 18 GAUGE, WITH 8" CENTERS. PROVIDE WITH 8" RIGID SPOUT GOOSENECK FAUCET WITH 4" WRIST BLADE CONTROL HANDLES, REAR CENTERED CRUMB CUP STRAINER DRAIN, ¾" ANGLE SUPPLIES WITH STOPS, KENTUCKY CODE P-TRAP, TAILPIECE AND ESCUTCHEONS. PROVIDE WITH AIR GAP FITTING.	1/2"	1/2"	2"	2"	-	1.5
<u>P-4A</u>	SINGLE COMPARTMENT SINK WITH GRID STRAINER  SINGLE COMPARTMENT STAINLESS STEEL SINK, 19"X21" O.D., 14"X18" I.D., 6½" DEEP, 18 GAUGE, WITH 8" CENTERS. PROVIDE WITH 8" RIGID SPOUT GOOSENECK FAUCET WITH 4" WRIST BLADE CONTROL HANDLES, REAR CENTERED GRID STRAINER DRAIN, ¾" ANGLE SUPPLIES WITH STOPS, KENTUCKY CODE P-TRAP, TAILPIECE AND ESCUTCHEONS. PROVIDE WITH AIR GAP FITTING.	1/2"	½"	2"	2"	-	1.5
<u>P-5</u>	DOUBLE COMPARTMENT SINK W/SINGLE LEVER FAUCET  DOUBLE COMPARTMENT STAINLESS STEEL SINK, 20"X37" O.D., 14"X16" I.D., 18 GAUGE, 6½" DEEP, REAR FAUCET LEDGE WITH 8" CENTERS. PROVIDE WITH SINGLE LEVER SWING SPOUT FAUCET. PROVIDE WITH CHROME SUPPLIES, STOPS, TAILPIECE, KENTUCKY CODE P-TRAP, CRUMB CUP STRAINER DRAINS, CONTINUOUS WASTE AND ESCUTCHEONS. PROVIDE WITH AIR GAP FITTING FOR DISHWASHER. PROVIDE IN-SINK-AERATOR OR EQUAL BADGER 5 GARBAGE DISPOSAL, WITH ½ HP MOTOR AND WALL SWITCH.	½"	<i>½</i> "	2"	2"	-	1.5
<u>P-6</u>	ELECTRIC WATER COOLER — BI—LEVEL — ADA COMPLIANT  BI—LEVEL BARRIER FREE WATER COOLER WITH SINGLE COMPRESSOR, WATER SUPPLY, DRAIN AND ELECTRICAL CONNECTION. 8.0 GPH OF 50°F WATER AT 90°F AMBIENT AND 80°F INLET WATER, 18.8 GAUGE STAINLESS STEEL BASIN, ½ HP COMPRESSOR, 115V/1PH, SURFACE MOUNTED TO THE WALL WITH CHILLER BELOW BOWL AND SIDE AND FRONT PUSH BAR OPERATORS. MOUNT SO THE BOTTOM OF THE LOWER COOLER IS AT 9" MINIMUM AFF WITH A CLEARANCE OF 27" MINIMUM FROM THE BOTTOM OF THE APRON OF THE BOWL TO THE FINISHED FLOOR. THE DIMENSION TO THE CENTERLINE OF THE LOWER COOLER BUBBLER SHALL BE 35". PROVIDE WITH CANE TOUCH APRON ATTACHED TO THE HI COOLER. PROVIDE WITH INTEGRAL BOTTLE FILLING STATION WITH NO—TOUCH, SENSOR ACTIVATED BOTTLE FILLER WITH AUTO 20—SECOND SHUTOFF AND A FILL RATE OF 1.1 GPM. PROVIDE WITH STAINLESS STEEL COOLER CABINET.	-	1/2"	2"	2"	-	-
<u>P-7</u>	SHOWER PROVIDE A PRESSURE BALANCING MIXING VALVE WITH COMBINATION INTEGRAL DIVERTER AND VOLUME CONTROL, ADJUSTABLE SCREW TO LIMIT HANDLE TURN, AND A SHOWER HEAD WITH ARM AND FLANGE. PROVIDE ZURN ZN-415 OR EQUAL FLOOR DRAIN WITH TYPE "B" STRAINER.	3⁄4"	34"	2"	2"	-	1.6
<u>P-7A</u>	SHOWER — ADA COMPLIANT PROVIDE A PRESSURE BALANCING MIXING VALVE WITH COMBINATION INTEGRAL DIVERTER AND VOLUME CONTROL, ADJUSTABLE SCREW TO LIMIT HANDLE TURN, SHOWER HEAD WITH ARM AND FLANGE, AND A WALL/HAND SHOWER WITH FLEXIBLE METAL HOSE AND 30" SLIDE BAR FOR HAND SHOWER MOUNTING. PROVIDE ZURN ZN-415 OR EQUAL FLOOR DRAIN WITH TYPE "B" STRAINER.	3⁄4"	34"	2"	2"	-	1.6
<u>P-8</u>	MOP BASIN 24"X24"X10" HIGH MOLDED STONE MOP SERVICE BASIN, IN WHITE DRIFT COLOR, 3" DRAIN, SERVICE FAUCET, HOSE AND HOSE BRACKET, AND VINYL BUMPERGUARD. THE DRAIN SHALL BE LOCATED 12" TO THE CENTER. PROVIDE A CHECK VALVE IN THE HOT AND COLD WATER SUPPLIES.	¾"	34"	3"	2"	-	2.5
<u>P-9</u>	WATER SUPPLY WALL BOX  10" x 8-1/2" RECESSED WATER VALVE BOX, 18 GAUGE STEEL BOX WITH A SINGLE ½" WATER SUPPLY INLET, ANGLE STOP, AND ¼" COMPRESSION OUTLET.	-	<b>½</b> "	-	-	-	-
<u>HB</u>	HOSE BIBB  ZURN MODEL Z1350 OR EQUAL ENCASED MODERATE CLIMATE WALL HYDRANT FOR NARROW WALL INSTALLATION. WITH ALL BRONZE BODY, ALL BRONZE INTERIOR PARTS, REPLACEABLE SEAT WASHER, LOOSE KEY OPERATED CONTROL VALVE, VACUUM BREAKER AND 3/4" MALE HOSE CONNECTION. ADJUSTABLE STAINLESS STEEL BOX FURNISHED WITH HINGED COVER CYLINDER LOCK AND "WATER" STAMPED ON THE COVER. MOUNTED WITH HOSE CONNECTION AT 18" ABOVE FINISHED FLOOR ELEVATION OF AREA SERVED.	_	1/2"	-	-	-	-
<u>HB2</u>	HOSE BIBB (EXPOSED) WOODFORD MODEL 24 OR EQUAL WITH LOOSE KEY HANDLE POLISHED CHROME FINISH, BRASS CONSTRUCTION. MOUNT HOSE BIBB 18" ABOVE FINISHED FLOOR ELEVATION OF AREA SERVED. REFER TO MECHANICAL SPECIFICATION FOR ADDITIONAL REQUIREMENTS.	-	<i>½</i> "	-	_	_	-
<u>FD-1</u>	FLOOR DRAIN — 6" DIA.  ZURN, ZN-415 OR EQUAL FLOOR DRAIN WITH 6" DIAMETER TOP, TYPE "B" NICKEL BRONZE STRAINER, 4" DRAIN OUTLET AND TRAP PRIMER CONNECTION.	_	_	4"	2"	-	_
<u>FD-2</u>	FLOOR DRAIN — 12"X12"  ZURN, ZN—610 OR EQUAL, FLOOR DRAIN WITH 12"X12" LOCKING GRATE, SECONDARY STRAINER, SEDIMENT BUCKET AND GALVANIZED CAST IRON CONSTRUCTION WITH TRAP PRIMER CONNECTION; NICKEL BRONZE STRAINER; 4" DRAIN OUTLET.	-	-	4"	2"	-	-
<u>FD-3</u>	<u>FLOOR DRAIN — FUNNEL</u> ZURN, ZN—415 OR EQUAL FLOOR DRAIN WITH TYPE "E" STRAINER, WITH COMBINATION FUNNEL GRATE WITH PERIMETER OPENINGS, STRAINER SHALL BE NICKEL BRONZE. 4" DRAIN OUTLET.	_		3"	2"	_	

EXPANSION TANKS								
MARK	MANUFACTURER MODEL	SERVICE	VOLUME (GAL)	MAX ACCEPT. FACTOR				
HWEX-1	AMTROL ST-8	WH-1	3.2	.59				

WATER HEATER SCHEDULE									
MARK	MANUFACTURER MODEL	SERVICE	STORAGE (GAL)	RECOVERY GPH @ 100°F RISE	KW	ELECTRICAL (VOLT/PH)	REMARKS		
WH-1	A.O. SMITH - DEN-66	120°F	66	18	4.5	208/3	1, 2, 3		

1. SINGLE POINT ELECTRICAL CONNECTION. 2. IMMERSION TYPE THERMOSTATS TO CONTROL WATER TEMPERATURE. 3. MODULATING STEP CONTROLS SHALL BE PROVIDED FOR THIS WATER HEATER.

	REVISIONS	DATE	COUNCIL O	F STATE GOVERNME	NTS - HEADQUARTER	S BUILDING
2				2760 RESEARCH PARK DRIV	/E LEXINGTON, KY 40511	
3			RECORD DATE NOV. 2013	SCHEDULES DETAILS	DRAWING NO	
5 6			DRAWN BY <b>MCW</b>	COMMONWEALT FINANCE AND ADMIN	H OF KENTUCKY VISTRATION CABINET	P-4.0
7 8			CHECKED BY  CMR	DEPARTMENT FOR FACILITE  FRANKFORT	& CONTRACT ADMINISTRATION IES AND SUPPORT SERVICES , KENTUCKY	1-4.0
9			1302.00 CSG13	⊙mni ⁄>	212 North Upper Street Lexington, Kentucky 40507-1001 p 859,252,6664 f 859,253,2358	REVIEWED DIV. OF ENGR.
			NOV. 2013	ARCHITECTS	www.omnlarchitects.com	ENGR. FILE NC 785-C6BR-BC01-00
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			DIVISION OF ENGINEERING	APPROVED FOR PROGRAM	DAT	E
				APPROVED FOR PROGRAM	M CONCEPT ONLY	

