



- 1 STRUCTURAL CONCRETE FOUNDATION - SEE STRUCTURAL DRAWINGS FOR DIMENSIONS, BEARING POINTS AND REINFORCING
- 2 STRUCTURAL CONCRETE SLAB - SEE STRUCTURAL DRAWINGS FOR DIMENSIONS, REINFORCING, AND ENGINEERED FILL
- 3 EXPOSED CAST-IN-PLACE CONCRETE SURFACE - DO NOT PAINT
- 4 EXPOSED CAST-IN-PLACE CONCRETE SURFACE BEYOND
- 5 EXPOSED CAST-IN-PLACE CONCRETE WEARING SLAB OVER RIGID INSULATION OVER MEMBRANE FLASHING OVER STRUCTURAL CONCRETE SLAB
- 6 LIGHTWEIGHT CONCRETE TOPPING OVER STRUCTURAL CONCRETE SLAB - SLOPE AT 1/4" PER FOOT TO DRAIN AS SHOWN ON ROOF PLAN
- 7 EXPOSED CAST-IN-PLACE CONCRETE WITH ARCHITECTURAL FINISH AND RUSTICATION JOINTS
- 8 CONCRETE REVEAL FOR SURFACE MOUNTED LIGHT FIXTURE
- 9 CONCRETE MASONRY UNITS WITH HORIZONTAL JOINT REINFORCING AT 16" ON CENTER VERTICALLY - SEE FINISH SCHEDULE FOR FINISH
- 10 EXPOSED STEEL STRUCTURE WITH INTUMESCENT PAINTED FINISH - SEE STRUCTURAL DRAWINGS FOR SIZE AND DIMENSIONS
- 11 STEEL STRUCTURE - SEE STRUCTURAL DRAWINGS FOR SIZE AND DIMENSIONS
- 12 EXPOSED STEEL STRUCTURE WITH PAINTED FINISH - SEE STRUCTURAL DRAWINGS FOR SIZE AND DIMENSIONS
- 13 METAL ROOF DECK - SEE STRUCTURAL DRAWINGS FOR DEPTH AND GAUGE
- 14 STEEL EDGE ANGLE - SEE STRUCTURAL DRAWINGS FOR SIZE AND DIMENSIONS
- 15 18 GAUGE COLD-FORMED METAL STUDS AT 16" ON CENTER
- 16 18 GAUGE COLD-FORMED METAL FRAMING MEMBER TO STEEL STRUCTURE WITH SLIP JOINT FOR DEFLECTION
- 17 SLOPED CONCRETE SURFACE
- 18 PROVIDE DOUBLE STUDS AT THIS LOCATION, TYPICAL
- 19 METAL STUDS AT 16" ON CENTER
- 20 METAL FRAMING AT 16" ON CENTER
- 21 EXTERIOR ALUMINUM GUARDRAIL WITH BLACK FLOORPOLYMER FINISH - 42" HIGH
- 22 METAL HANDRAIL / GUARDRAIL WITH PAINTED FINISH
- 23 HOLLOW METAL DOOR AND FRAME WITH PAINTED FINISH
- 24 FIRE-TREATED WOOD BLOCKING
- 25 SHIM AS REQUIRED AT PERIMETER
- 26 SOLID SURFACING WINDOW SILL
- 27 APPROXIMATE FINISH GRADE - SEE SITE DRAWINGS FOR ELEVATION
- 28 AIR INFILTRATION BARRIER WITH TAPED JOINTS OVER 1/2" GLASSMATT FACED EXTERIOR GYPSUM SHEATHING ON EXTERIOR FACE OF WALL AND 6 MIL VAPOR BARRIER ON INTERIOR FACE OF WALL - FILL WALL CAVITY WITH BATT INSULATION
- 29 BACKER ROD AND SEALANT
- 30 BACKER ROD AND SEALANT IN COMPOSITE ALUMINUM PANEL JOINTS IN THIS LOCATION ONLY
- 31 COMPOSITE ALUMINUM SPANDREL PANEL WITH FINISH TO MATCH SURROUNDING FRAME
- 32 COMPOSITE ALUMINUM PANEL SYSTEM WITH FLUOROPOLYMER FINISH (COLOR SELECTED BY ARCHITECT WITH CONCEALED FASTENERS, ALUMINUM MOUNTING TRACERS, AND FINISH REQUIRED - EACH PANEL TO HAVE FLASHING AND WEAP HOLE - DO NOT CALK OR GASKET JOINTS BETWEEN PANELS)
- 33 COMPOSITE ALUMINUM PANEL SYSTEM WITH FLUOROPOLYMER FINISH TO MATCH ALUMINUM COMPOSITE PANEL COLOR
- 34 EXTRUDED ALUMINUM COPING WITH FLUOROPOLYMER FINISH TO MATCH ALUMINUM COMPOSITE PANEL COLOR
- 35 EXTRUDED ALUMINUM FASCIA ROOF GABLE WITH FLUOROPOLYMER FINISH TO COLOR
- 36 HOT ASPHALT APPLIED MULTI-PLY SBS MODIFIED BITUMEN ROOFING SYSTEM OVER POLYISOCYANURATE INSULATION BOARD - INSULATION TO BE APPROVED BY ROOFING MANUFACTURER - PROVIDE PROTECTION BOARD WHERE REQUIRED BY ROOFING MANUFACTURER
- 37 SLOPE RIGID INSULATION BOARD AT 1/4" PER FOOT TO DRAIN AS SHOWN ON ROOF PLAN - R-20 AVERAGE
- 38 UNIFORM THICKNESS RIGID INSULATION BOARD - R-20 MINIMUM
- 39 1/2" GLASSMATT FACED GYPSUM THERMAL BARRIER BOARD
- 40 THERMALLY-BROKEN ALUMINUM STOREFRONT FRAMING SYSTEM WITH BLACK FLUOROPOLYMER FINISH
- 41 TRANSLUCENT COMPOSITE FIBERGLASS PANELS WITH ALUMINUM FRAME WITH FLUOROPOLYMER FINISH TO MATCH ALUMINUM COMPOSITE PANEL COLOR
- 42 THERMALLY-BROKEN ALUMINUM CURTAINWALL FRAMING SYSTEM WITH FLUOROPOLYMER FINISH TO MATCH ALUMINUM COMPOSITE PANEL COLOR
- 43 THERMALLY-BROKEN ALUMINUM SKYLIGHT WITH FLUOROPOLYMER FINISH
- 44 1" INSULATING CLEAR GLAZING WITH LOW-EMISSIVITY COATING
- 45 1" INSULATING GREY TINTED GLAZING WITH LOW-EMISSIVITY COATING
- 46 5/8" GYPSUM BOARD OVER VAPOR BARRIER OVER RIGID INSULATION OVER 2" METAL FURRING
- 47 5/8" GYPSUM BOARD - SEE FINISH SCHEDULE FOR FINISHES AND WALL TYPE SCHEDULE FOR RATED MATERIALS
- 48 5/8" GYPSUM BOARD BEYOND
- 49 SUSPENDED ACOUSTIC CEILING SYSTEM WITH 2'x2' PANELS - SEE FINISH SCHEDULE FOR PANEL TYPES
- 50 3 1/2" TAPERED RESILIENT BASE - SEE SCHEDULE FOR TYPE
- 51 WALL BASE - SEE SCHEDULE FOR TYPE
- 52 STEEL ACOUSTIC LOUVER WITH FLUOROPOLYMER FINISH TO MATCH ALUMINUM COMPOSITE PANEL COLOR
- 53 LABORATORY CASEWORK - SEE ENLARGED PLANS AND DETAILS FOR CONFIGURATION AND DIMENSIONS
- 54 LIGHTWEIGHT CONCRETE TOPPING OVER STRUCTURAL METAL DECK - SLOPE AT 1/4" PER FOOT TO DRAIN AS SHOWN ON ROOF PLAN
- 55 EXPOSED CONCRETE FLOOR SLAB WITH TROWEL FINISH AND CLEAR HARDENERY SEAL
- 56 8" HIGH SURFACE-MOUNTED CAST ALUMINUM LETTERS / NUMBERS
- 57 COMPOSITE DRAINAGE / PROTECTION BOARD WITH INTEGRAL FILTER FABRIC OVER RUBBERIZED ASPHALT WATERPROOFING MEMBRANE - PROVIDE FOUNDATION DRAINS AS SHOWN
- 58 1" DEEP REVEAL IN CONCRETE SURFACE
- 59 5/8" GYPSUM BOARD OVER METAL FRAMING AT 10" ON CENTER
- 60 STRUCTURAL CONCRETE FRAME AND SLAB - SEE STRUCTURAL DRAWINGS FOR DIMENSIONS AND REINFORCING
- 61 EXPOSED STEEL STAIR SYSTEM WITH PAINTED FINISH - FILL STEEL TREAD PANS WITH CONCRETE AND PROVIDE 1 1/2" DIAMETER PIPE HANDRAILS AND GUARDRAILS AT 42" ABOVE FLOOR
- 62 FLOOR FINISH - SEE ROOM FINISH SCHEDULE FOR TYPE

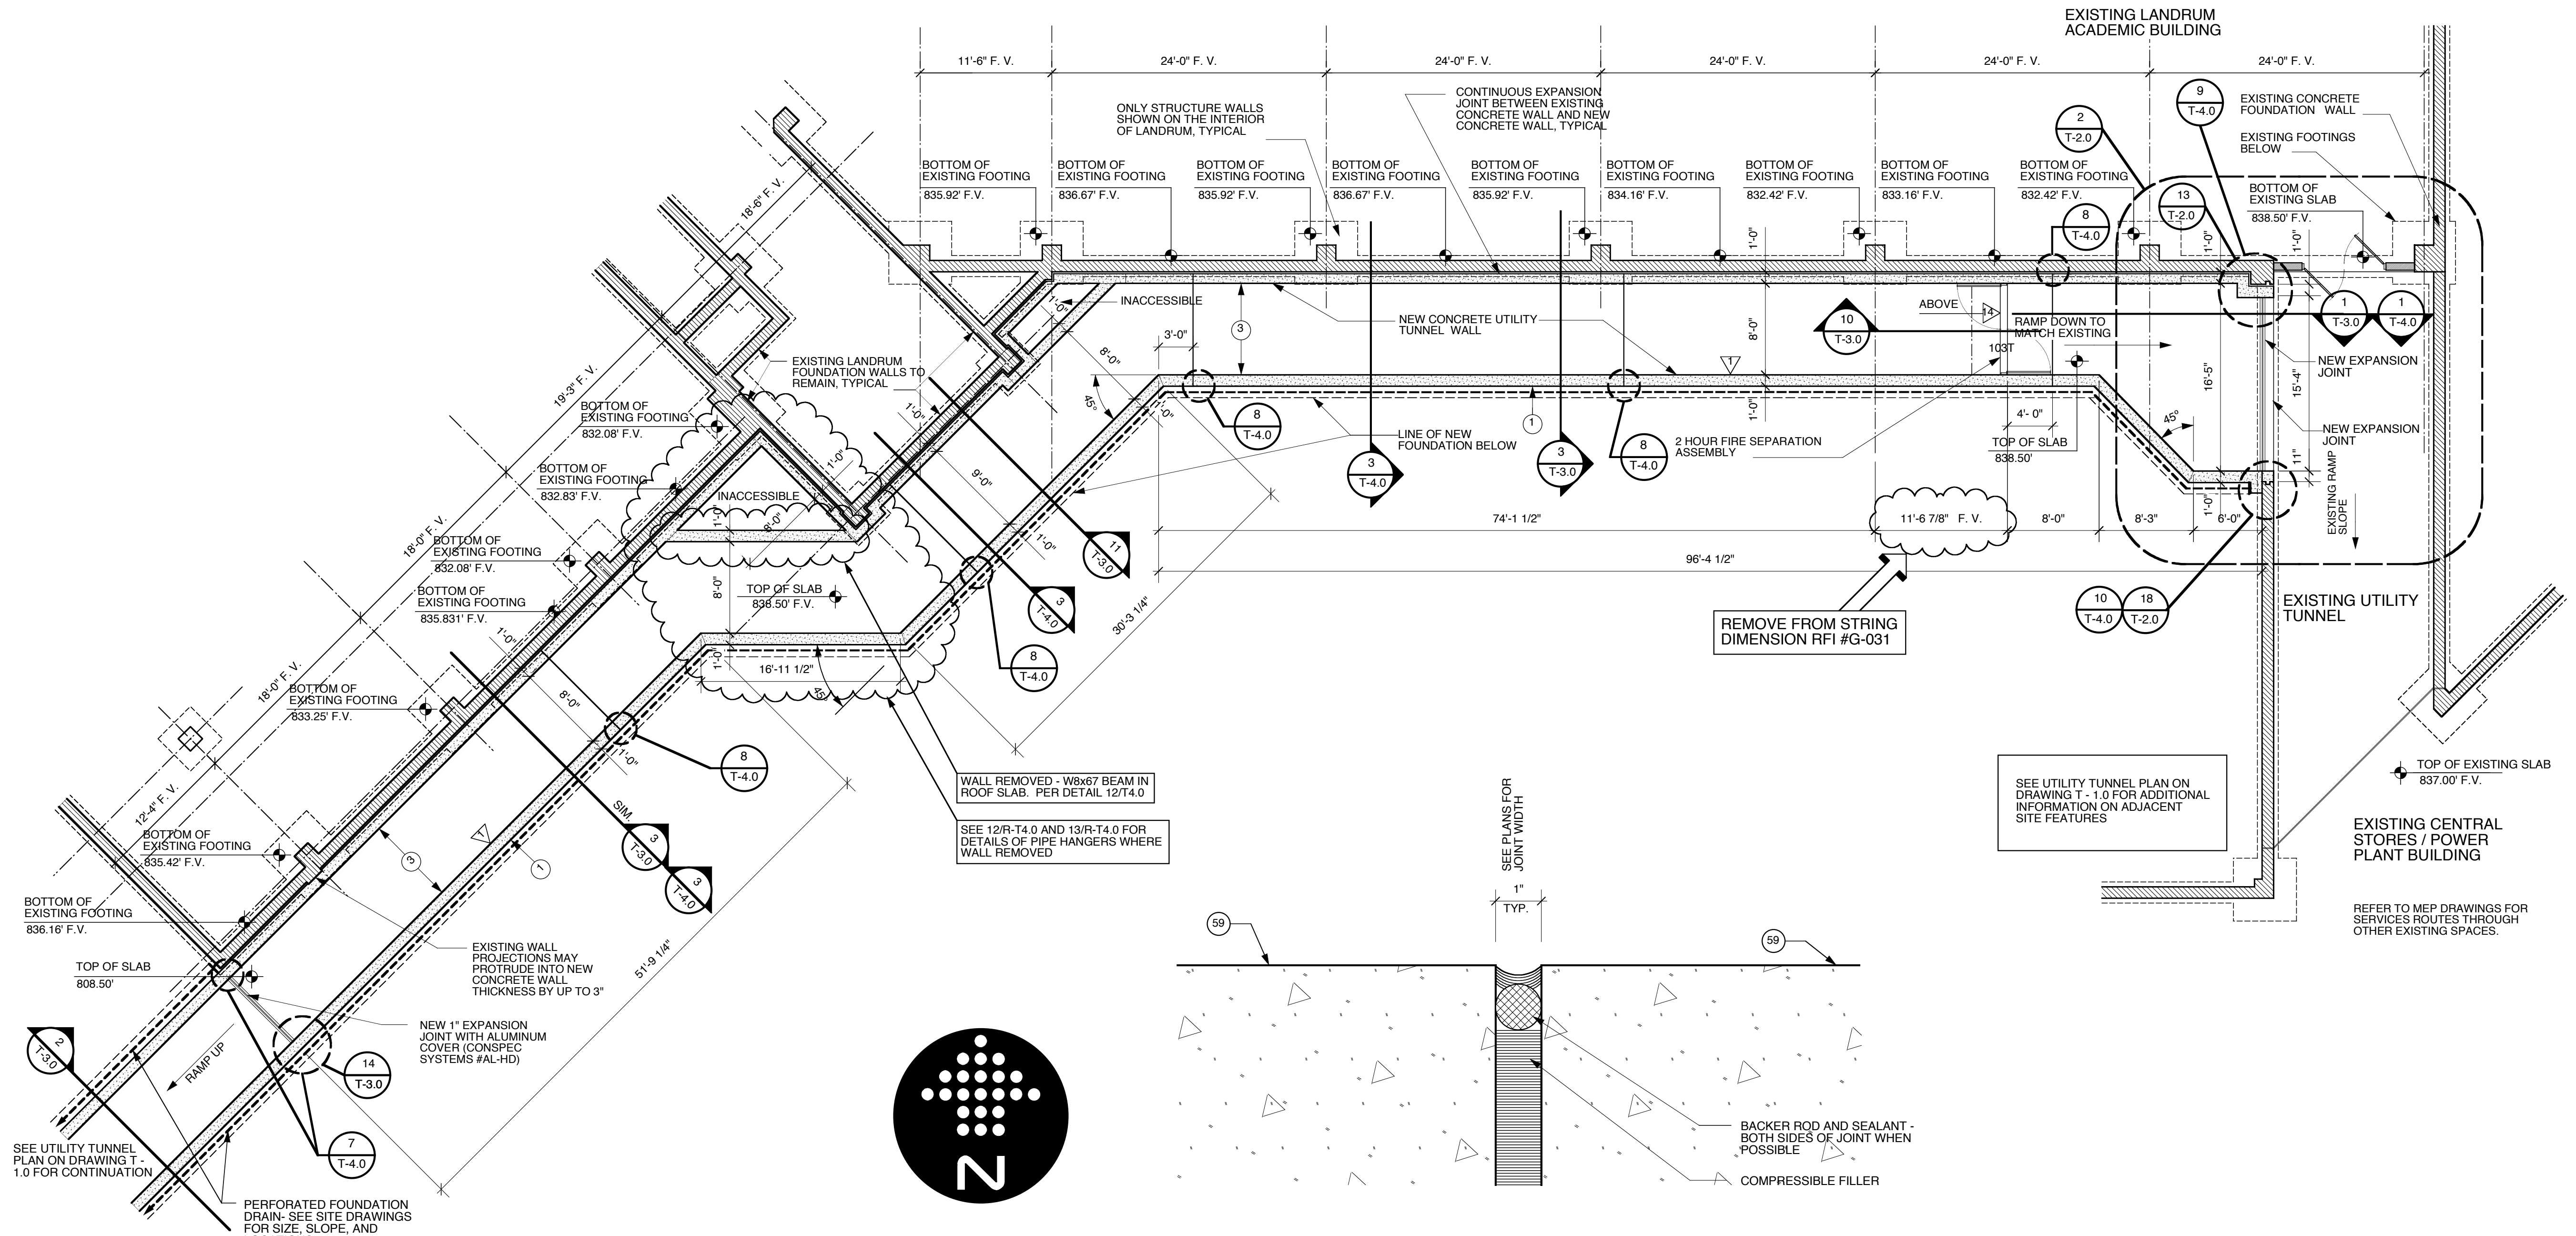


**1 ENLARGED PLAN @ UTILITY TUNNEL AT LANDRUM**  
1/8" = 1'-0"


**3 FLOOR DETAIL @ EXPANSION JOINT**  
6" = 1'-0"

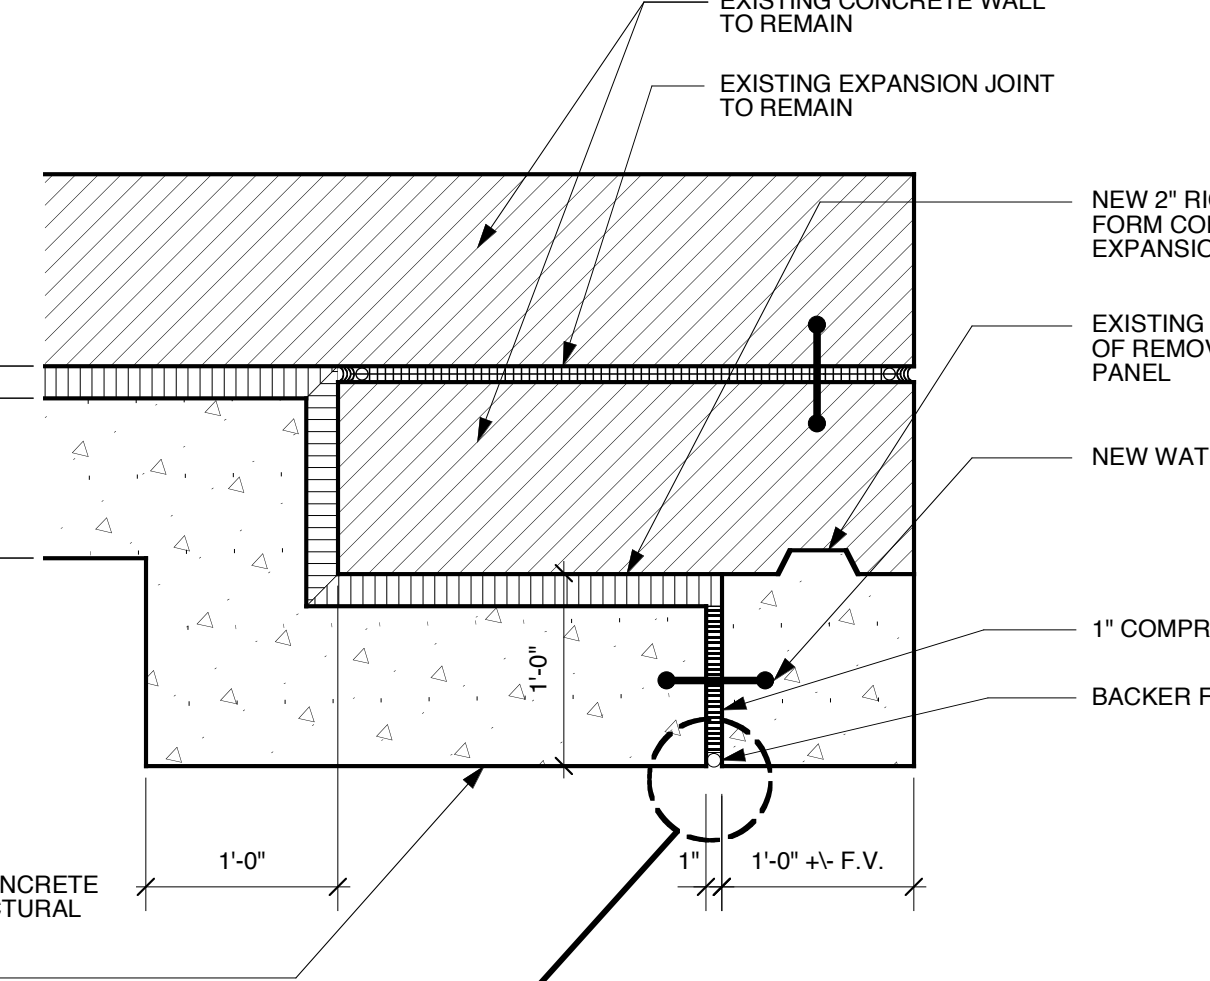

**13 PLAN DETAIL @ WALL**  
1" = 1'-0"

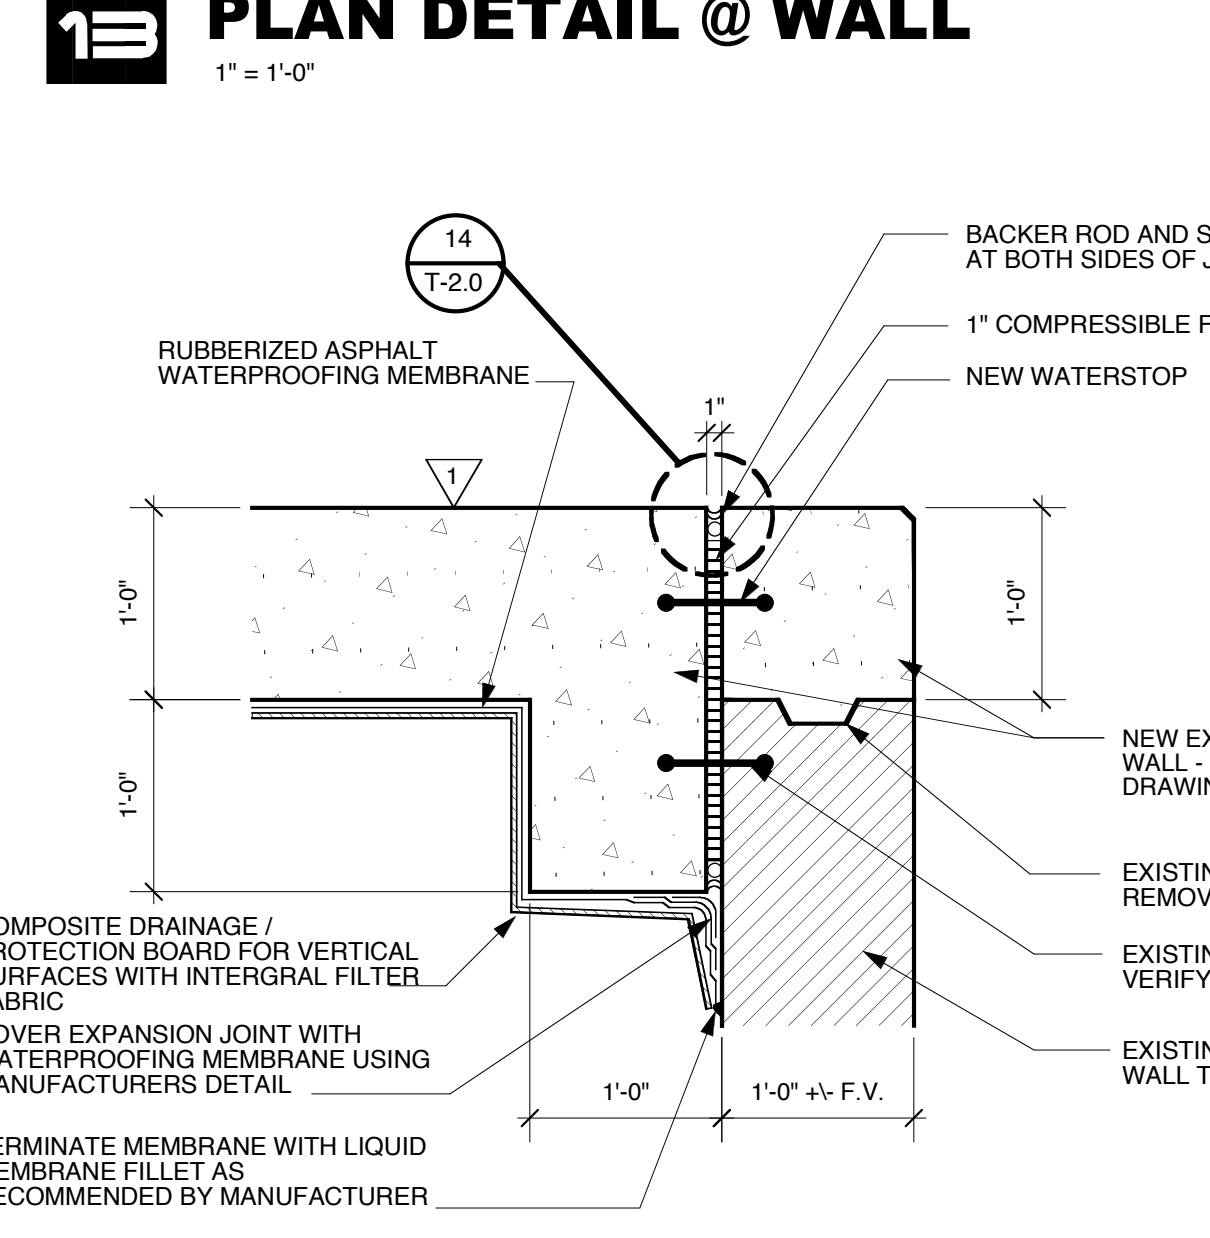


**16 SEE SECTION 10/T-4.0 FOR REINFORCING DETAILS**  
**16 PLAN DETAIL @ WALL**  
1" = 1'-0"

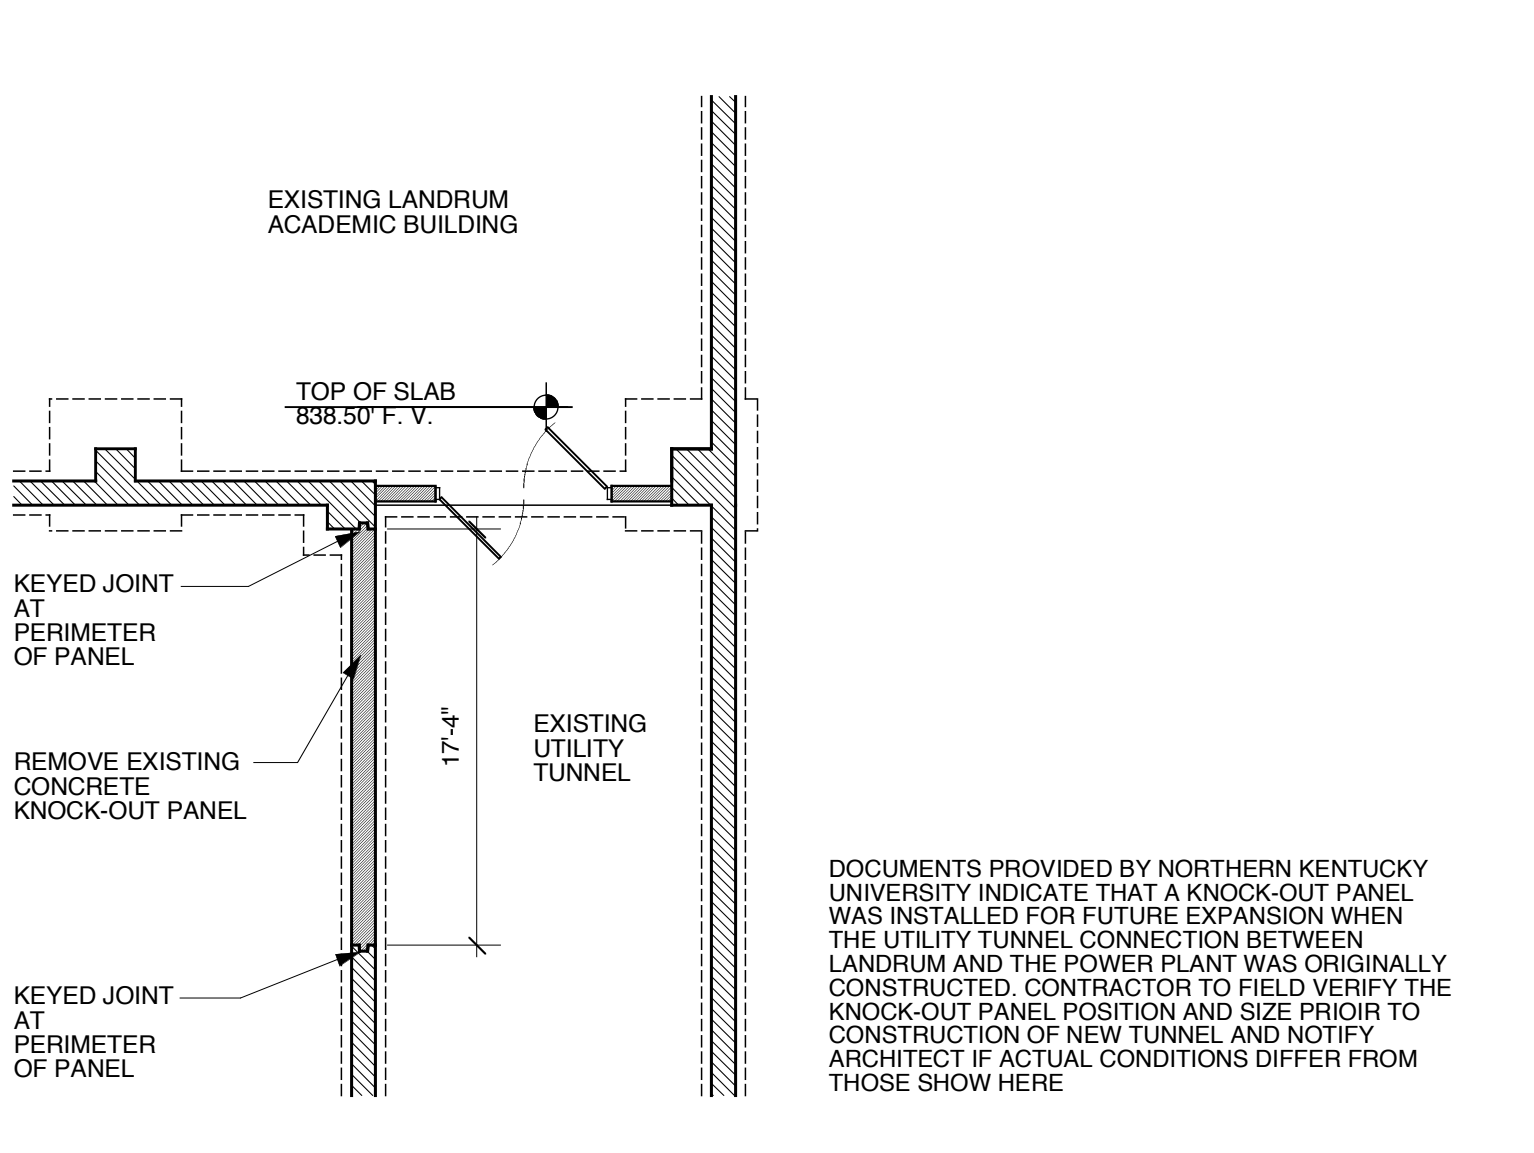

**2 DEMOLITION PLAN @ EXISTING UTILITY TUNNEL**  
1/8" = 1'-0"

**10 CEILING DETAIL @ EXPANSION JOINT**  
6" = 1'-0"

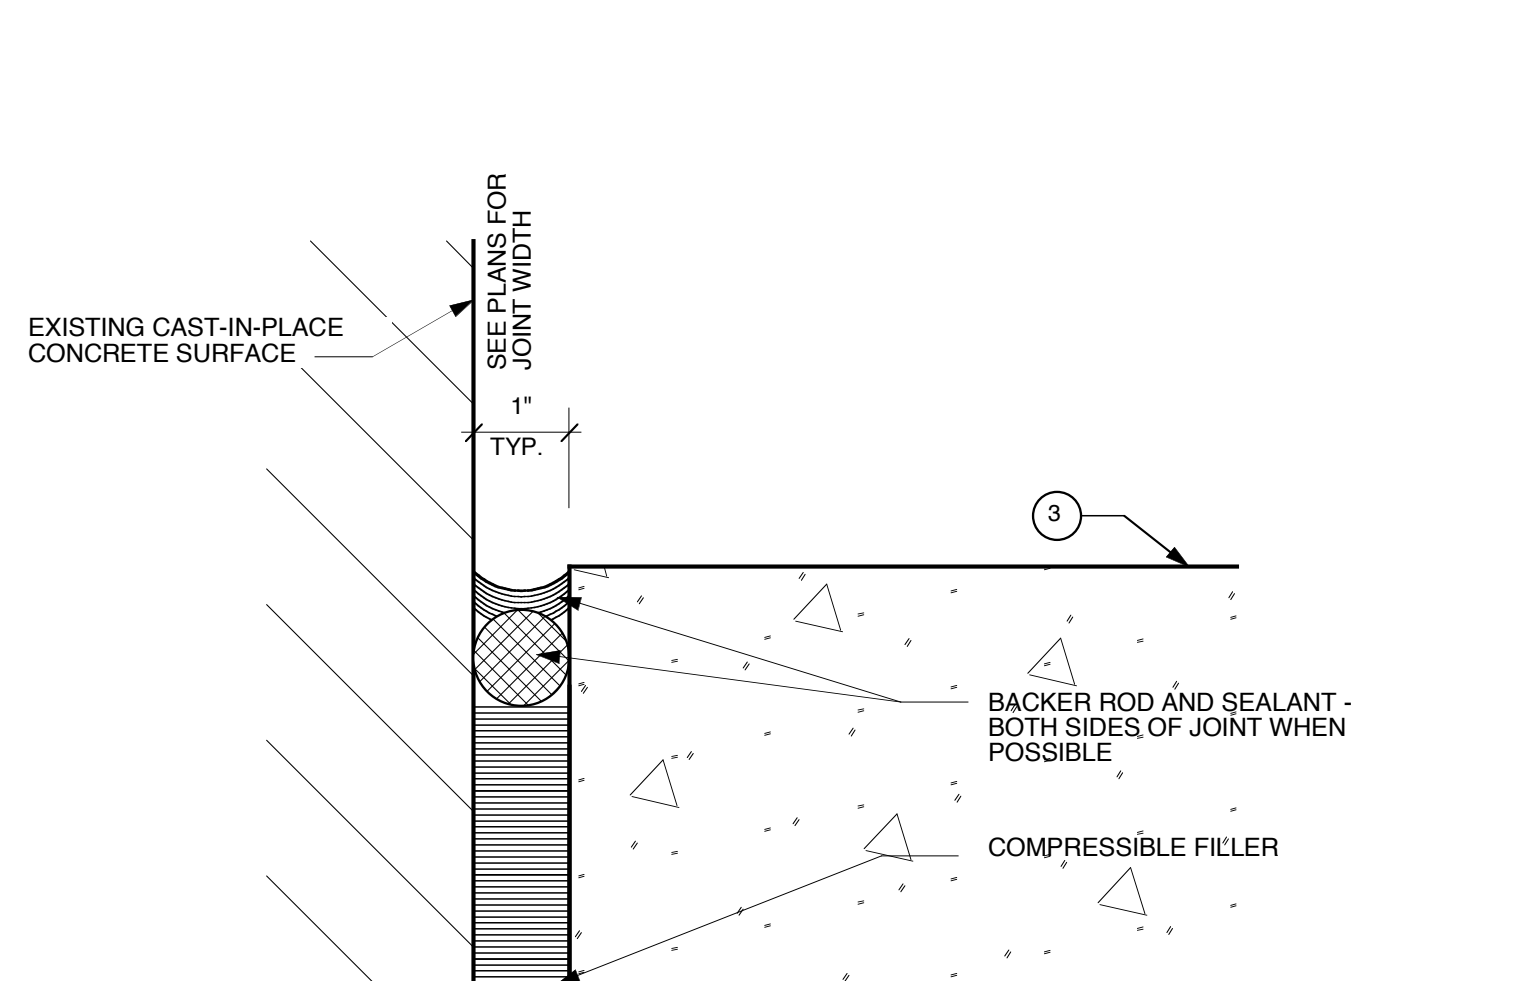

**15 EXISTING @ EXPANSION JOINT COVER**  
6" = 1'-0"


**RECORD DOCUMENTS**  
These Record Documents have been prepared based on information provided by others. The Consultant has not verified the accuracy and/or completeness of this information and shall not be responsible for any errors or omissions that may be incorporated as a result of erroneous information provided by others.

**Omni ARCHITECTS** 12/1/02 DATE

**ENLARGED PLANS / DETAILS**

# T-2.0

**4 ENLARGED PLAN @ EXISTING NATURAL SCIENCE**  
1/8" = 1'-0"

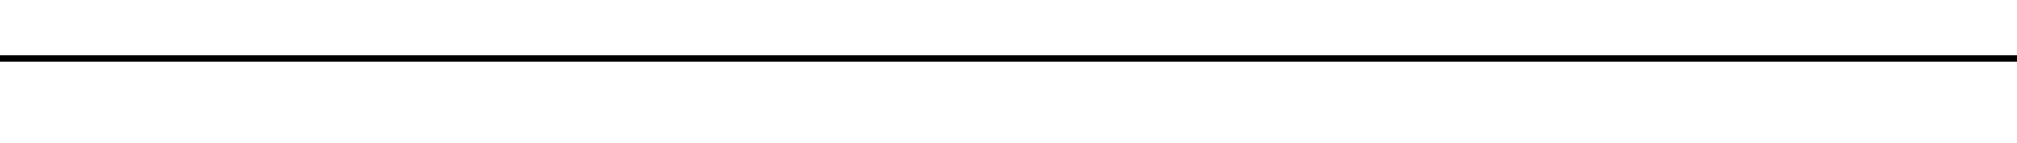

REVISIONS	DATE	RECORD DATE
1		
2		
3		
4		
5		
6		
7		
8		
9		

<b>NORTHERN KENTUCKY UNIVERSITY</b>		DRAWING NO.
<b>NATURAL SCIENCE BUILDING</b>		<b>T-2.0</b>
DRAWN BY	COMMONWEALTH OF KENTUCKY	REVIEWED
CHECKED BY	FINANCE AND ADMINISTRATION CABINET	
DATE	DEPARTMENT FOR FACILITIES MANAGEMENT	DATE
6/99	FRANKFORT, KENTUCKY	
AGENCY		ENGR. FILE NO.
AUTHORIZED AGENT		<b>1-111</b>
APPROVED FOR PROGRAM CONCEPT ONLY		DATE
APPROVED FOR PROGRAM CONCEPT ONLY		DATE